STANDARD CONSTRUCTION DETAILS

REVISED 2017-2018



STANDARD CONSTRUCTION DETAILS



TOWNSHIP OF BRANCHBURG

1077 Route 202 North Branchburg, New Jersey 08876-3936 TELE: (908)526-1300 FAX: (908)526-2452

STANDARD CONSTRUCTION DETAILS

DOUGLAS A. BALL, P.E., TOWNSHIP ENGINEER

DATE: 2012 SCALE : NTS DRAWN BY: JAR REV: 2018

INDEX

ROAD DETAILS

- 1. ROAD SECTION
- 2. BELGIAN BLOCK CURB
- 3. CONCRETE BLOCK CURB
- 4. CONCRETE DRIVEWAY APRON
- 5. CONCRETE SIDWALKS
- 6. SIDEWALK LOCATION 40X40 INTERSECTION
- 7. SIDEWALK LOCATION 50X50 INTERSECTION
- 8. SIDEWALK LOCATION 60X50 INTERSECTION
- 9. INTERSECTIONS
- 9A. PLACEMENT OF DETECTABLE WARNING SURFACE
- 10. CUL-DE-SAC (CENTERED0
- 11. CUL-DE-SAC (LEFT/RIGHT)
- 12. PAVEMENT SECTIONS
- 13. TRENCH PATCH REPAIR
- 14. GUIDE RAIL (WOOD BARRICADE)
- 15. STREET SIGN
- 16. TRAFFIC SIGN

SANITARY SEWERS

- 17. CONCRETE BLOCK MANHOLE
- 18. PRECAST CONCRETE DROP MANHOLE
- 19. SEWER LATERAL CONNECTION
- 20. MANHOLE FRAME & COVER
- 21. WATERTIGHT MANHOLE FRAME & COVER
- 22. SEWER RISER & SADDLE CONNECTION
- 23. SEWER TRENCH SECTION

STORM & SANITARY SEWERS

- 24. PRECAST MANHOLE CONCRETE SLAB
- 25. MANHOLE CHANNEL DETAIL
- 26. POLYPROPYLENE STEPS DETAIL
- 27. PRECAST MANHOLE DETAIL
- 28 28A. DOGHOUSE DETAIL

STORM SEWERS

- 29. CONCRETE BLOCK INLET
- 30. PRECAST CONCRETE INLET
- 31. ECO TYPE B INLET CASTING
- 32. TYPE A INLET CASTING
- 33. TYPE E INLET CASTING
- 34. MANHOLE CASTING
- 35. 45° INLET SETTING
- 36. INLET TO MANHOLE CONVERSION
- 37. STANDARD PRECAST HEADWALL
- 38. STANDARD PRECAST WINGED HEADWALL
- 39. PRECAST FLARED END SECTION
- **40. TRENCH SECTION DETAIL**
- 41. GRASS DRAINAGE SWALE (TYPICAL)
- 42. OUTLET STRUCTURE & DETENTION FACILITY
- A. Outlet Structure
- B. Outlet Structure Cross Section
- C. Detention Facility Cross Section
- C-1 Temporary Sediment Basin Cross Section
- D. Impervious Clay Core
- E. Weir Trash Rack
- F. Trash Rack
- G. Orifice Plate
- H. Anit-Seep Collars

MISCELLANEOUS DETAILS

- 43. UNDERDRAIN DETAIL (TYPICAL)
- 44. SILT FENCE DETAIL (TYPICAL)
- 45. PARKING HAIRPIN STRIPING
- **46. TRAFFIC MARKINGS**
- 47. BITUMINOUS SIDEWALKS
- 48. DETECTABLE / WARNING SURFACE TILE
- 49. HANDICAP PARKING SIGN
- 50. TRASH ENCLOSURE DETAIL
- 51. STORM SEWER DOWELED CONCRETE HEADWALL



TOWNSHIP OF BRANCHBURG

1077 Route 202 North Branchburg, New Jersey 08876-3936 TELE: (908)526-1300 FAX: (908)526-2452 STANDARD CONSTRUCTION DETAILS INDEX

DOUGLAS A. BALL, P.E., TOWNSHIP ENGINEER

DATE: 2010 SCALE: NTS DRAWN BY: JAR REV: 2018

GENERAL NOTES

- A) MANHOLE DESIGN SPECIFICATIONS MUST CONFORM TO "PRECAST REINFORCED CONCRETE MANHOLE SECTIONS" A.S.T.M. C478, LATEST REVISION.
- B) ALL PVC SANITARY SEWER PIPE SHALL CONFORM TO A.S.T.M. SPECIFICATIONS D-3034 SDR 35, 400' MAXIMUM DISTANCE BETWEEN MANHOLES.
- C) ALL CONSTRUCTION SHALL BE IN ACCORDANCE WITH THE "NJDOT STANDARD SPECIFICATIONS FOR ROAD AND BRIDGE CONSTRUCTION", AND THE "NJ RESIDENTIAL SITE IMPROVEMENT STANDARDS", MOST CURRENT EDITION.
- D) PAVEMENT SECTIONS SHALL CONFORM WITH THE TOWNSHIP OF BRANCHBURG LAND USE ORDINANCE SECTION 5-3. ALL TRAFFIC MARKINGS SHALL CONFORM WITH THE MUTCD 2009 OR LATEST EDITION.
- E) ALL TRAFFIC SIGNS, THERE SIZES AND POSITIONS MUST BE IN ACCORDANCE WITH THE LATEST EDITION OF THE FEDERAL HIGHWAY ADMINISTRATION AND THE MANUAL ON UNIFORM TRAFFIC CONTROL DEVICES 2009 OR LATEST EDITION.
- F) HANDICAP ACCESSIBILITY SHOULD CONFORM WITH THE FOLLOWING; AMERICAN DISABILITIES ACT THE BARRIER SUBCODE OF THE NJ UNIFORM CONSTRUCTION CODE (NJAC5:23-7) ADAAG AND SHALL BE APPLICABLE FOR ALL SITE IMPROVEMENTS. PROWAG SHALL BE APPLICABLE TO ANY PUBLIC RIGHT OF WAYS OR TITLE 39 ENFORCED ROADWAYS.




TOWNSHIP OF BRANCHBURG

1077 Route 202 North Branchburg, New Jersey 08876-3936 TELE: (908)526-1300 FAX: (908)526-2452 STANDARD CONSTRUCTION DETAILS

GENERAL NOTES

DOUGLAS A. BALL, P.E., TOWNSHIP ENGINEER

DATE: 2010 SCALE: NTS DRAWN BY: JAR DATE: 2018

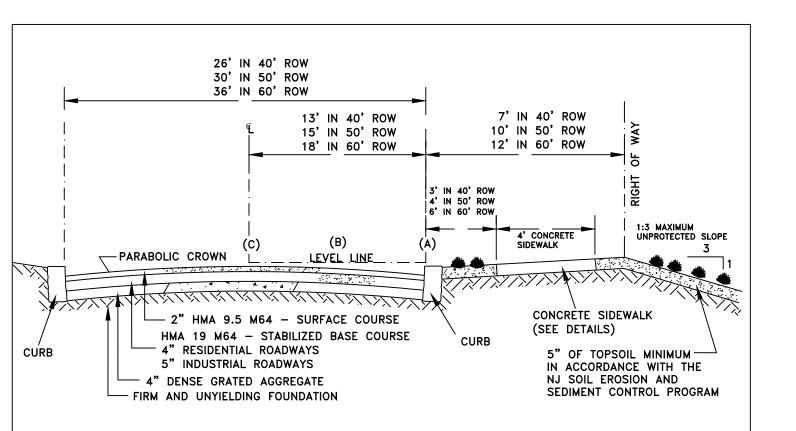

DISTANCES DOWN FROM LEVEL LINE, FROM TOP OF CURB, TO CREATE A PARABOLIC CROWN: (SEE SECTION ABOVE)

PRIOR TO INSTALLING:		DGA STONE	<u>HMA 19 M64</u>	HMA 9.5 M64
40' RIGHT OF WAY (5" CROWN) (6" FINISHED CURB FACE) (26' PAVEMENT)	(A) (B) (C)	16" 12½" 11"	12" 8½" 7"	8" 4½" 3"
50' RIGHT OF WAY (6" CROWN) (6" FINISHED CURB FACE) (30' PAVEMENT)	(A) (B) (C)	16" 11½" 10"	12" 7½" 6"	8" 3½" 2"
60' RIGHT OF WAY (7" CROWN) (8" FINISHED CURB FACE) (36' PAVEMENT)	(A) (B) (C)	19" 13¾" 12"	15" 9¾" 8"	10" 4¾" 3"

ROAD SECTION


Not to Scale




TOWNSHIP OF BRANCHBURG

1077 Route 202 North Branchburg, New Jersey 08876-3936 TELE: (908)526-1300 FAX: (908)526-2452 STANDARD CONSTRUCTION DETAILS ROAD ROAD SECTION

DOUGLAS A. BALL,	P.E., TOWNSHIP ENGINEER	₹ '		
DATE: 2-1-10	SCALE : NTS	DRAWN BY: JAR	REV: 2018	1

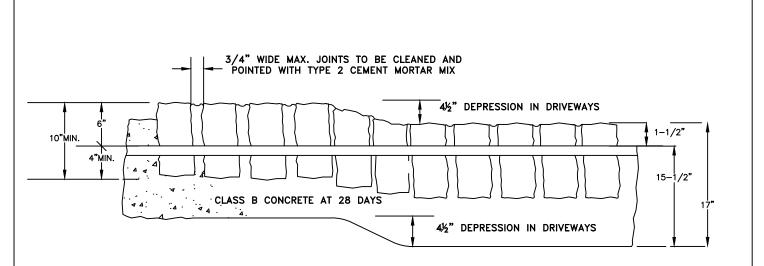

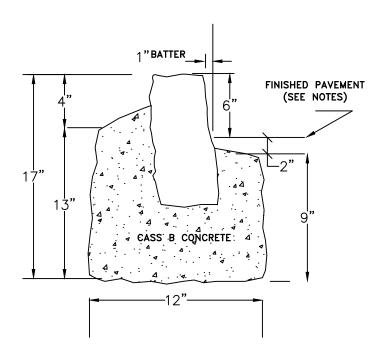

- 1. AN APPLICATION TO OPEN PUBLIC GROUNDS IS REQUIRED BY THE ENGINEERING DEPARTMENT WHEN WORKING IN THIS AREA.
- 2. ANY ROADWAY REPAIRS SHALL FOLLOW THE TRENCH / PATCH REPAIR DETAILS.
- 3. GRANITE CURBS SHALL BE INSTALLED VERTICALLY IN ALL LOCATIONS INCLUDING ALL DEPRESSED LOCATIONS AND SHALL BE 10" IN HEIGHT BY 4" DEPTH AVERAGE SIZE.


BELGIAN BLOCK CURB



TOWNSHIP OF BRANCHBURG

1077 Route 202 North Branchburg, New Jersey 08876-3936 TELE: (908)526-1300 FAX: (908)526-2452 STANDARD CONSTRUCTION DETAILS ROAD ROAD BELGIAN BLOCK CURB

DOUGLAS A. BALL,	P.E., TOWNSHIP ENGINEE	R		
DATE: 2010	SCALE : NTS	DRAWN BY: JAR	REV: 2018	2

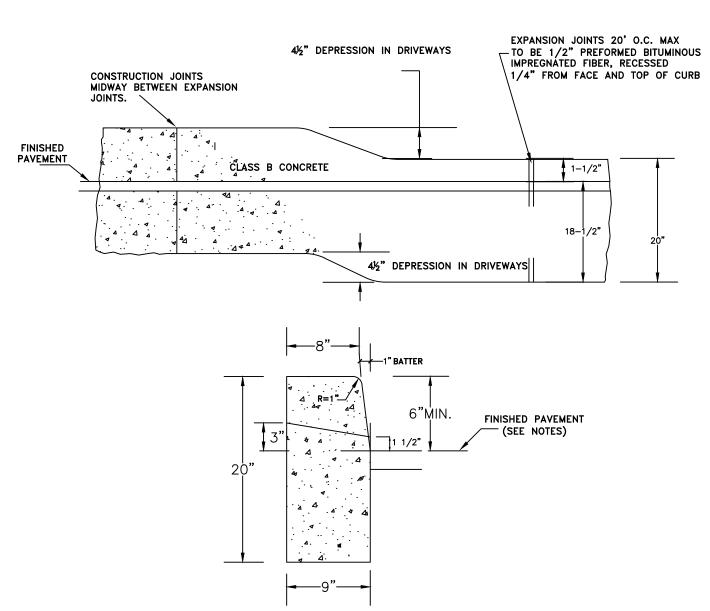

- 1. AN APPLICATION TO OPEN PUBLIC GROUNDS IS REQUIRED BY THE ENGINEERING DEPARTMENT WHEN WORKING IN THIS AREA.
- 2. ANY ROADWAY REPAIRS SHALL FOLLOW THE TRENCH / PATCH REPAIR DETAILS.
- 3. DEPRESSIONS IN ALL HANDICAP ACCESSIBLE LOCATIONS SHALL BE FLUSH WITH THE SURFACE.

CONCRETE CURB




TOWNSHIP OF BRANCHBURG

1077 Route 202 North Branchburg, New Jersey 08876-3936 TELE: (908)526-1300 FAX: (908)526-2452 STANDARD CONSTRUCTION DETAILS ROAD CONCRETE CURB

DOUGLAS A. BALL, P.E., TOWNSHIP ENGINEER

DATE: 2010 SCALE : NTS DRAWN BY: JAR REV: 2018

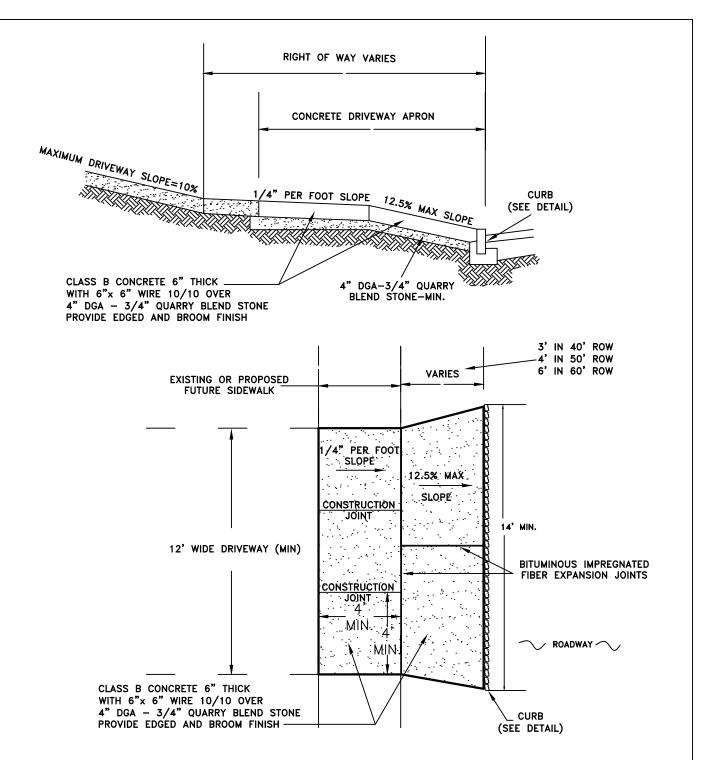

NOTE: AN APPLICATION TO OPEN PUBLIC GROUNDS IS REQUIRED BY THE ENGINEERING DEPARTMENT WHEN WORKING IN THIS AREA.

CONCRETE DRIVEWAY APRON

Not to Scale




TOWNSHIP OF BRANCHBURG

1077 Route 202 North Branchburg, New Jersey 08876-3936 TELE: (908)526-1300 FAX: (908)526-2452

STANDARD CONSTRUCTION DETAILS ROAD CONCRETE DRIVEWAY APRON

DOUGLAS A. BALL,	P.E., TOWNSHIP ENGINEEI	?		
DATE: 2-1-10	SCALE : NTS	DRAWN BY: JAR	REV: 2018	4

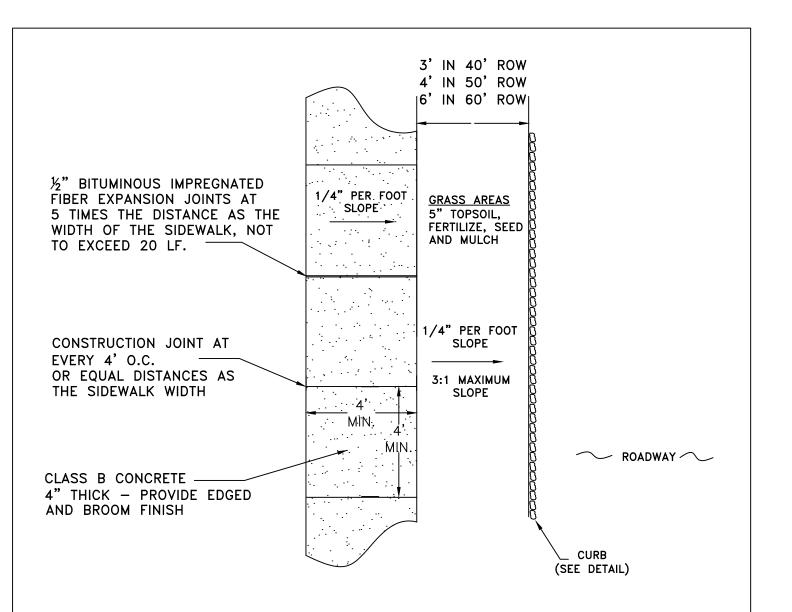

NOTE: AN APPLICATION TO OPEN PUBLIC GROUNDS IS REQUIRED BY THE ENGINEERING DEPARTMENT WHEN WORKING IN THS AREA.

CONCRETE SIDEWALK


Not to Scale



TOWNSHIP OF BRANCHBURG

1077 Route 202 North Branchburg, New Jersey 08876-3936 TELE: (908)526-1300 FAX: (908)526-2452 STANDARD CONSTRUCTION DETAILS
ROAD
CONCRETE SIDEWALK

DOUGLAS A. BALL,	P.E., TOWNSHIP ENGINEER	R .		
DATE: 2010	SCALE : NTS	DRAWN BY: JAR	REV: 2018	5

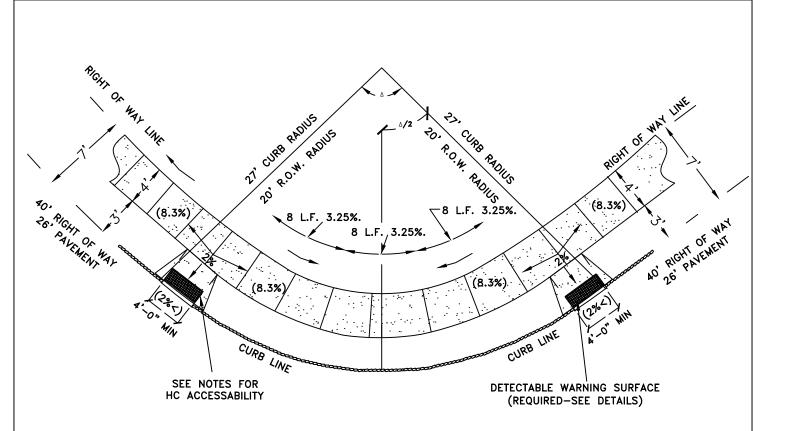

- 1. ALL HANDICAP RAMPS MUST BE DESIGNED BY A LICENSED ENGINEER OR NJPLS AND SUBMITTED TO THE TOWNSHIP ENGINEER FOR REVIEW.
- 2. HANDICAP ACCESSIBILITY SHOULD CONFORM WITH THE FOLLOWING; AMERICAN DISABILITIES ACT THE BARRIER FREE SUBCODE OF THE NJ UNIFORM CONSTRUCTION CODE (NJAC5:23-7) ADAAG SHALL BE APPLICABLE FOR ALL SITE IMPROVEMENTS. PROWAG SHALL BE APPLICABLE TO ANY PUBLIC RIGHT OF WAYS AND TITLE 39 ENFORCED ROADWAYS.
- 3. DETECTABLE WARNING SURFACE ARE REQUIRED ON ALL HANDICAP ACCESSIBLE LOCATION. (SEE DETAIL)
- 4. AN APPLICATION TO OPEN PUBLIC GROUNDS MAY BE REQUIRED BY THE BRANCHBURG ENGINEERING DEPARTMENT WHEN WORKING IN THIS AREA.

SIDEWALK LOCATION

(40X40 INTERSECTION)
Not to Scale




TOWNSHIP OF BRANCHBURG

1077 Route 202 North Branchburg, New Jersey 08876-3936 TELE: (908)526-1300 FAX: (908)526-2452 STANDARD CONSTRUCTION DETAILS

ROAD
SIDEWALK LOCATION 40X40 INTERSECTION

Douglas A. Ball, P.	E., Township Engineer			
DATE: 2-1-10	SCALE : NTS	DRAWN BY: JAR	REV. 2018	6

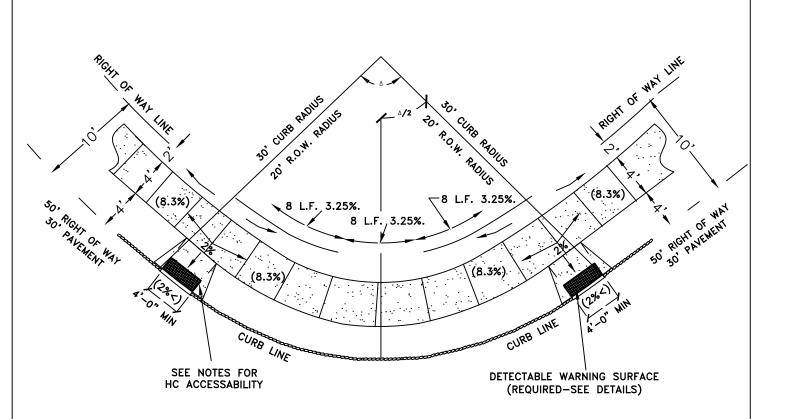

- 1. ALL HANDICAP RAMPS MUST BE DESIGNED BY A LICENSED ENGINEER OR NJPLS AND SUBMITTED TO THE TOWNSHIP ENGINEER FOR REVIEW.
- 2. HANDICAP ACCESSIBILITY SHOULD CONFORM WITH THE FOLLOWING; AMERICAN DISABILITIES ACT THE BARRIER FREE SUBCODE OF THE NJ UNIFORM CONSTRUCTION CODE (NJAC5:23-7) ADAAG SHALL BE APPLICABLE FOR ALL SITE IMPROVEMENTS. PROWAG SHALL BE APPLICABLE TO ANY PUBLIC RIGHT OF WAYS AND TITLE 39 ENFORCED ROADWAYS.
- 3. DETECTABLE WARNING SURFACE ARE REQUIRED ON ALL HANDICAP ACCESSIBLE LOCATION. (SEE DETAIL)
- 4. AN APPLICATION TO OPEN PUBLIC GROUNDS MAY BE REQUIRED BY THE BRANCHBURG ENGINEERING DEPARTMENT WHEN WORKING IN THIS AREA.

SIDEWALK LOCATION

(50X50 INTERSECTION)
Not to Scale




TOWNSHIP OF BRANCHBURG

1077 Route 202 North Branchburg, New Jersey 08876-3936 TELE: (908)526-1300 FAX: (908)526-2452 STANDARD CONSTRUCTION DETAILS ROAD

SIDEWALK LOCATION 50X50 INTERSECTION

Douglas A. Ball, P.	E., Township Engineer	·		
DATE: 2-1-10	SCALE : NTS	DRAWN BY: JAR	REV. 2018	7

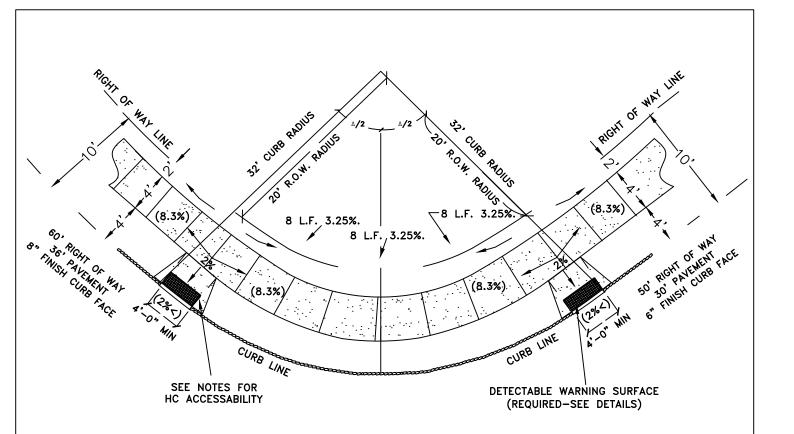

- 1. ALL HANDICAP RAMPS MUST BE DESIGNED BY A LICENSED ENGINEER OR NJPLS AND SUBMITTED TO THE TOWNSHIP ENGINEER FOR REVIEW.
- 2. HANDICAP ACCESSIBILITY SHOULD CONFORM WITH THE FOLLOWING; AMERICAN DISABILITIES ACT THE BARRIER FREE SUBCODE OF THE NJ UNIFORM CONSTRUCTION CODE (NJAC5:23-7) ADAAG SHALL BE APPLICABLE FOR ALL SITE IMPROVEMENTS. PROWAG SHALL BE APPLICABLE TO ANY PUBLIC RIGHT OF WAYS AND TITLE 39 ENFORCED ROADWAYS.
- 3. DETECTABLE WARNING SURFACE ARE REQUIRED ON ALL HANDICAP ACCESSIBLE LOCATION. (SEE DETAIL)
- 4. AN APPLICATION TO OPEN PUBLIC GROUNDS MAY BE REQUIRED BY THE BRANCHBURG ENGINEERING DEPARTMENT WHEN WORKING IN THIS AREA.

SIDEWALK LOCATION

(60X50 INTERSECTION)
Not to Scale




TOWNSHIP OF BRANCHBURG

1077 Route 202 North Branchburg, New Jersey 08876-3936 TELE: (908)526-1300 FAX: (908)526-2452 STANDARD CONSTRUCTION DETAILS ROAD

SIDEWALK LOCATION 60X50 INTERSECTION

Douglas A. Ball, P.	E., Township Engineer			
DATE: 2-1-10	SCALE : NTS	DRAWN BY: JAR	REV. 2018	8

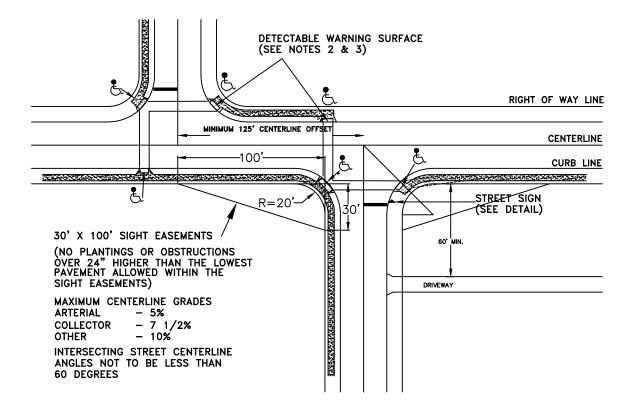

- 1. ALL HANDICAP RAMPS MUST BE DESIGNED BY A LICENSED ENGINEER OR NJPLS AND SUBMITTED TO THE TOWNSHIP ENGINEER FOR REVIEW.
- 2. HANDICAP ACCESSIBILITY SHOULD CONFORM WITH THE FOLLOWING; AMERICAN DISABILITIES ACT THE BARRIER FREE SUBCODE OF THE NJ UNIFORM CONSTRUCTION CODE (NJAC5:23-7) ADAAG AND SHALL BE APPLICABLE FOR ALL SITE IMPROVEMENTS. PROWAG SHALL BE APPLICABLE TO ANY PUBLIC RIGHT OF WAYS, TITLE 39 ENFORCED ROADWAYS.
- 3. DETECTABLE WARNING SURFACE ARE REQUIRED ON ALL HANDICAP ACCESSIBLE LOCATION. (SEE DETAIL)
- 4. AN APPLICATION TO OPEN PUBLIC GROUNDS MAY BE REQUIRED BY THE BRANCHBURG ENGINEERING DEPARTMENT WHEN WORKING IN THIS AREA.

Intersections Not to Scale





TOWNSHIP OF BRANCHBURG

1077 Route 202 North Branchburg, New Jersey 08876-3936 TELE: (908)526-1300 FAX: (908)526-2452

STANDARD CONSTRUCTION DETAILS ROAD INTERSECTIONS

DOUGLAS A. BALL,	P.E., TOWNSHIP ENGINEER	र		
DATE: 2-1-10	SCALE : NTS	DRAWN BY: JAR	REV: 2018	9

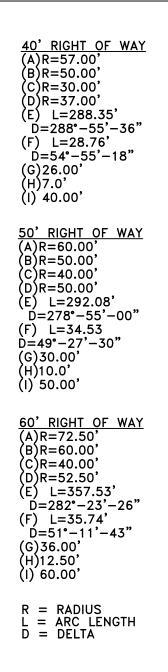

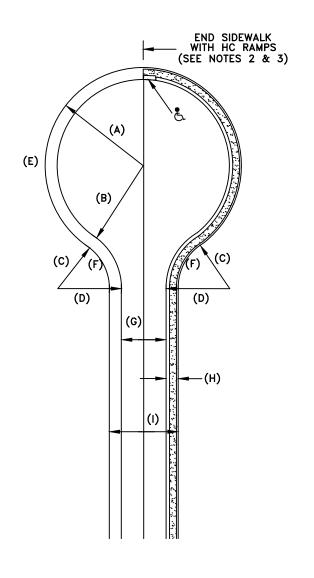

(CENTERED)

Not to Scale

NOTES:


- 1. ALL HANDICAP RAMPS MUST BE DESIGNED BY A LICENSED ENGINEER OR NJPLS AND SUBMITTED TO THE TOWNSHIP ENGINEER FOR REVIEW.
- 2. AND THE BARRIER FREE SUBCODE OF THE NJ UNIFORM CONSTRUCTION CODE (NJAC5:23-7) ADAAG SHALL BE APPLICABLE FOR ALL SITE IMPROVEMENTS. PROWAG SHALL BE APPLICABLE TO ANY PUBLIC RIGHT OF WAYS AND TITLE 39 ENFORCED ROADWAYS.
- 3. DETECTABLE WARNING SURFACE ARE REQUIRED ON ALL HANDICAP ACCESSIBLE LOCATION. (SEE DETAIL)
- 4. AN APPLICATION TO OPEN PUBLIC GROUNDS MAY BE REQUIRED BY THE BRANCHBURG ENGINEERING DEPARTMENT WHEN WORKING IN THIS AREA.



TOWNSHIP OF BRANCHBURG

1077 Route 202 North Branchburg, New Jersey 08876-3936 TELE: (908)526-1300 FAX: (908)526-2452 STANDARD CONSTRUCTION DETAILS ROAD CUL-DE-SAC (CENTERED)


DOUGLAS A. BALL,	P.E., TOWNSHIP ENGINEER	?		•
DATE: 2-1-10	SCALE : NTS	DRAWN BY: JAR	REV: 2018	10

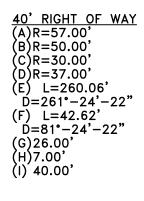

50' RIGHT OF WAY (A)R=60.00' (B)R=50.00' (C)R=40.00' (D)R=50.00' (E) L=267.58' D=255°-31'-19" (F) L=52.72' D=75°-31'-19" (G)30.00' (H)10.00' (I) 50.00'

60' RIGHT OF WAY (A)R=72.50' (B)R=60.00' (C)R=40.00' (D)R=52.50' (E) L=323.75' D=255°-51'-05" (F) L=52.95' D=75°-51'-05" (G)36.00' (H)12.50' (I) 60.00'

R = RADIUS L = ARC LENGTH D = DELTA

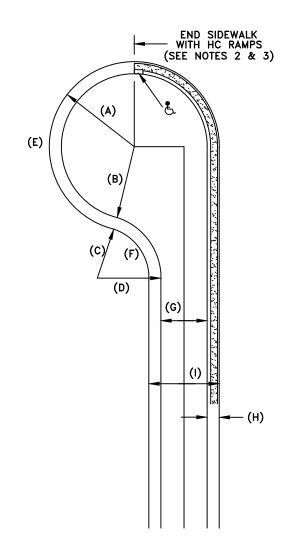

CUL-DE-SAC (LEFT OR RIGHT)

NOTES:


- 1. ALL HANDICAP RAMPS MUST BE DESIGNED BY A LICENSED ENGINEER OR NJPLS AND SUBMITTED TO THE TOWNSHIP ENGINEER FOR REVIEW.
- 2. AND THE BARRIER FREE SUBCODE OF THE NJ UNIFORM CONSTRUCTION CODE (NJAC5:23-7) ADAAG SHALL BE APPLICABLE FOR ALL SITE IMPROVEMENTS. PROWAG SHALL BE APPLICABLE TO ANY PUBLIC RIGHT OF WAYS AND TITLE 39 ENFORCED ROADWAYS.
- 3. DETECTABLE WARNING SURFACE ARE REQUIRED ON ALL HANDICAP ACCESSIBLE LOCATION. (SEE DETAIL)
- 4. AN APPLICATION TO OPEN PUBLIC GROUNDS MAY BE REQUIRED BY THE BRANCHBURG ENGINEERING DEPARTMENT WHEN WORKING IN THIS AREA.



TOWNSHIP OF BRANCHBURG

1077 Route 202 North Branchburg, New Jersey 08876-3936 TELE: (908)526-1300 FAX: (908)526-2452 STANDARD CONSTRUCTION DETAILS
ROAD
CUL-DE-SAC (LEFT OR RIGHT)

DOUGLAS A. BALL,	P.E., TOWNSHIP ENGINEEI	२		
DATE: 2-1-10	SCALE : NTS	DRAWN BY: JAR	REV: 2018	11

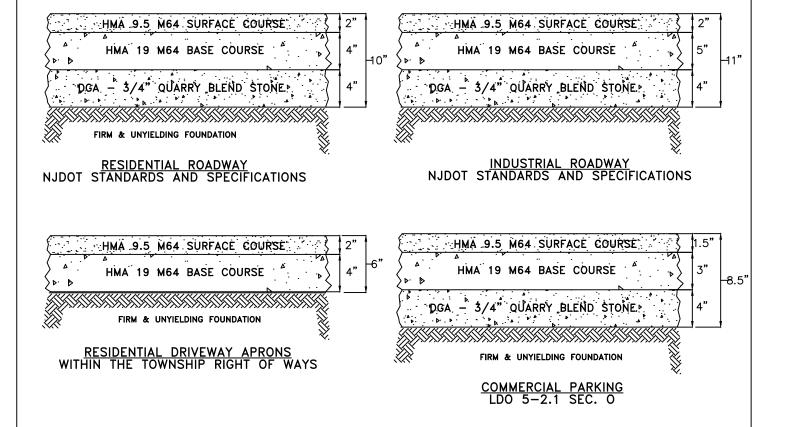

- 1. TACK COAT MATERIAL TO BE INSTALLED BETWEEN ASPHALT LAYERS AND EDGES WHERE NEW PAVEMENT MEETS EXISTING PAVEMENT.
- 2. AN APPLICATION TO OPEN PUBLIC GROUNDS IS REQUIRED IS REQUIRED BY THE BRANCHBURG TOWNSHIP ENGINEERING DEPARTMENT WHEN WORKING IN AREA.
- 3. ALL ROADWAY PAVEMENTS SHALL CONFORM TO RSIS OR THE NJDOT STANDARDS AND SPECIFICATIONS FOR ROAD AND BRIDGE CONSTRUCTION, MOST RECENT EDITION, WHICHEVER IS APPLICABLE.

PAVEMENT SECTIONS


Not to Scale



TOWNSHIP OF BRANCHBURG

1077 Route 202 North Branchburg, New Jersey 08876-3936 TELE: (908)526-1300 FAX: (908)526-2452 STANDARD CONSTRUCTION DETAILS
ROAD
PAVEMENT SECTIONS

DOUGLAS A. BALL,	P.E., TOWNSHIP ENGINEE	R		
DATE: 2-1-10	SCALE : NTS	DRAWN BY: JAR	REV: 2018	12

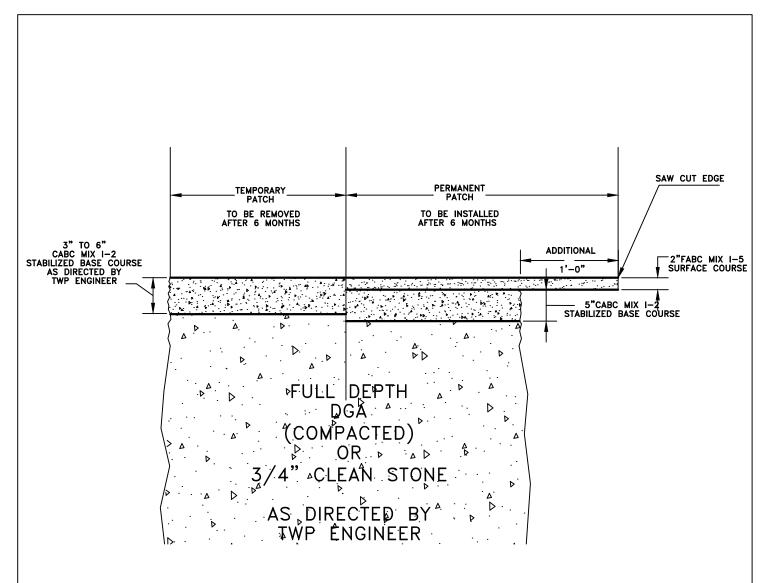

TACK COAT MATERIAL TO BE INSTALLED BETWEEN ASPHALT LAYERS AND EDGES. AN APPLICATION TO OPEN PUBLIC GROUNDS IS REQUIRED BY THE TOWNSHIP OF BRANCHBURG ENGINEERING DEPARTMENT WHEN WORKING IN THIS AREA.

TRENCH - PATCH PAVEMENT REPAIR TEMPORARY/PERMANENT Not to Scale




TOWNSHIP OF BRANCHBURG


1077 Route 202 North Branchburg, New Jersey 08876-3936 TELE: (908)526-1300 FAX: (908)526-2452

STANDARD CONSTRUCTION DETAILS ROAD PAVEMENT REPAIR

DOUGLAS A. BALL,	P.E., TOWNSHIP ENGINEER	₹		
DATE: 2-1-10	SCALE : NTS	DRAWN BY: JAR	REV: 2015	13

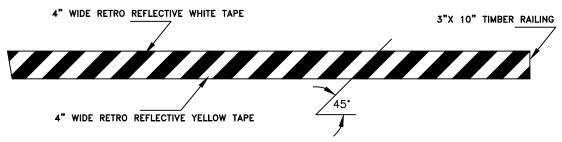

BARRICADE RAILING SPECIFICATIONS SAME AS BELOW

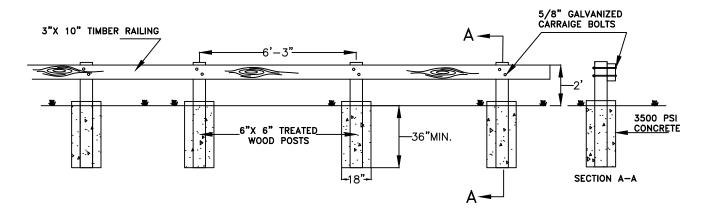

NOTE:

- 1. AN APPLICATION TO OPEN PUBLIC GROUNDS IS REQUIRED BY THE TOWNSHIP OF BRANCHBURG ENGINEERING DEPARTMENT WHEN WORKING IN THIS AREA.
- 2. GUIDE RAILS SHALL CONFORM TO NJDOT STANDARDS AND SPECIFICATIONS FOR ROAD AND BRIDGE CONSTRUCTION, MOST RECENT EDITION.


WOOD/BARRICADE RAIL Not to Scale



TOWNSHIP OF BRANCHBURG

1077 Route 202 North Branchburg, New Jersey 08876-3936 TELE: (908)526-1300 FAX: (908)526-2452 STANDARD CONSTRUCTION DETAILS
ROAD
GUIDE RAIL/BARRICADE SYSTEMS

DOUGLAS A. BALL,	P.E., TOWNSHIP ENGINEE	R		
DATE: 2-1-10	SCALE : NTS	DRAWN BY: JAR	REV: 2018	14

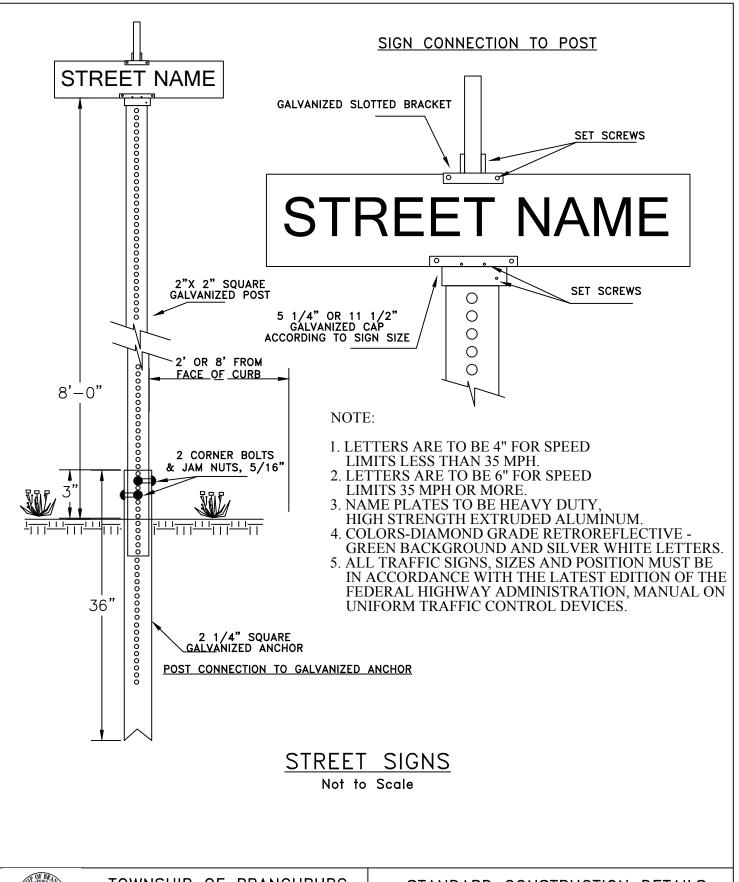




TOWNSHIP OF BRANCHBURG

1077 Route 202 North Branchburg, New Jersey 08876-3936 TELE: (908)526-1300 FAX: (908)526-2452 STANDARD CONSTRUCTION DETAILS
ROAD
STREET SIGNS

DOUGLAS A. BALL,	P.E., TOWNSHIP ENGINEER	२		
DATE:2-1-10	SCALE : NTS	DRAWN BY: JAR	REV:9/2014	15

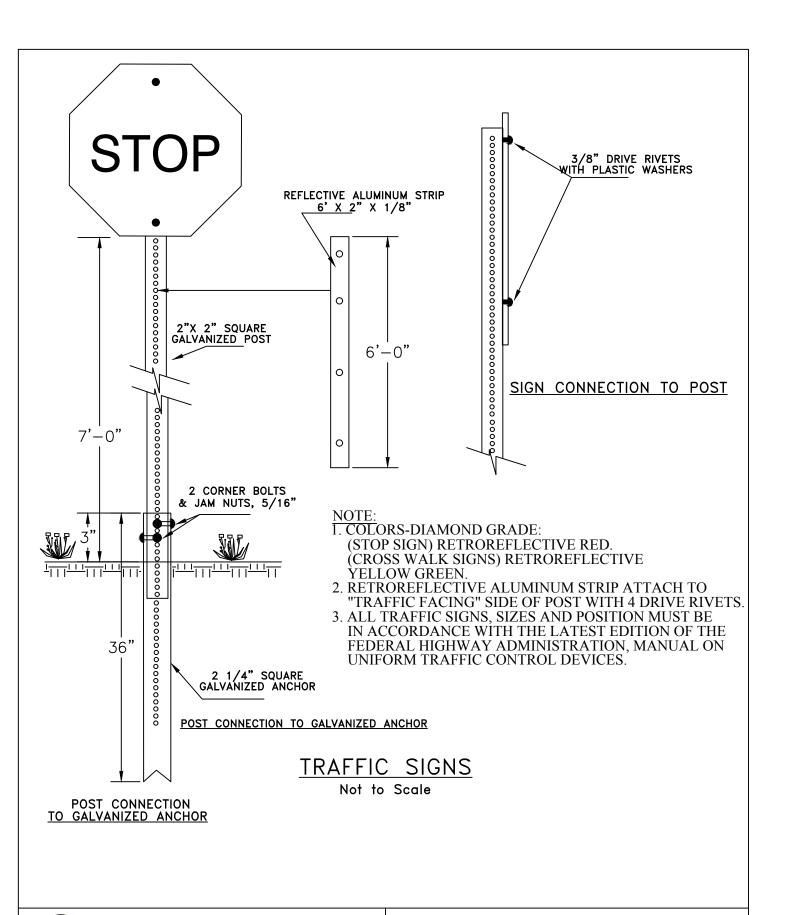




TOWNSHIP OF BRANCHBURG

1077 Route 202 North Branchburg, New Jersey 08876-3936 TELE: (908)526-1300 FAX: (908)526-2452 STANDARD CONSTRUCTION DETAILS
ROAD
TRAFFIC SIGNS

DOUGLAS A. BALL,	P.E., TOWNSHIP ENGINEER	र		
DATE: 2-1-10	SCALE : NTS	DRAWN BY: JAR	REV:9/2014	16

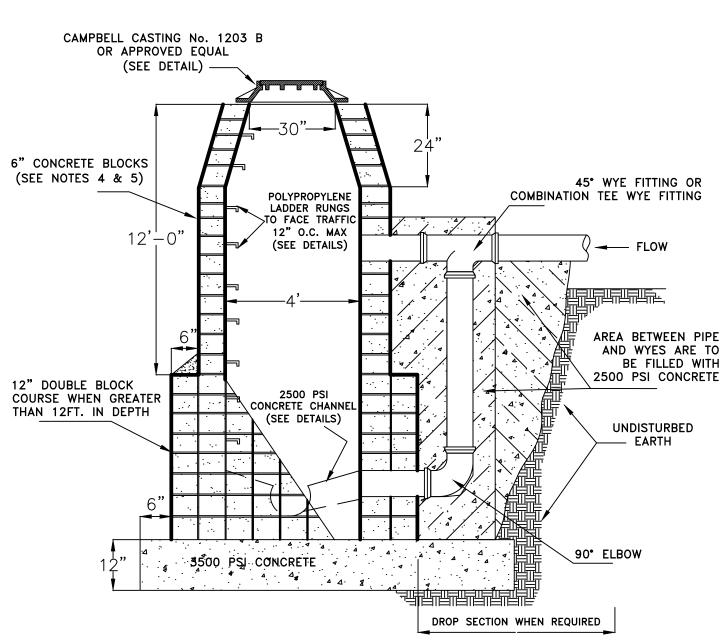

- 1. MANHOLES MUST PASS A VACUUM TEST AS PART OF THE REQUIREMENTS FOR SANITARY SEWER TESTING CHECKLIST, PROVIDED BY BRANCHBURG TOWNSHIP ENGINEERING DEPARTMENT.
- 2. PIPE COVERAGE TO FOLLOW THE "SANITARY SEWER TRENCH SECTION" DETAILS.
- 3. A MINIMUM OF 6" OF 3/4" CLEAN STONE SHALL BE USED AS BACKFILL ON ALL SIDES.
- 4. THE EXTERIOR AND INTERIOR WALLS TO BE PLASTERED WITH A MINIMUM 1/2" THICK COAT OF 1:2 CEMENT SAND MORTAR MIX, TROWELED TO A SMOOTH FINISH.
- 5. CONCRETE BLOCK SHALL BE SEALED WITH (2) COATS OF AN ACCEPTABLE WATERPROOFING TAR, ASPHALT, OR POLYPLASTIC ALLOY, WITH ENOUGH TIME ALLOWED BETWEEN THE SEAL COATS TO BOND.

CONCRETE BLOCK MANHOLE WITH DROP SECTION

Not to Scale




TOWNSHIP OF BRANCHBURG

1077 Route 202 North Branchburg, New Jersey 08876-3936 TELE: (908)526-1300 FAX: (908)526-2452 STANDARD CONSTRUCTION DETAILS
SANITARY SEWER
CONCRETE BLOCK MANHOLE W/ DROP

DOUGLAS A. BALL, P.E., TOWNSHIP ENGINEER

DATE: 2-1-10 | SCALE : NTS | DRAWN BY: JAR | REV: 2018 | 17

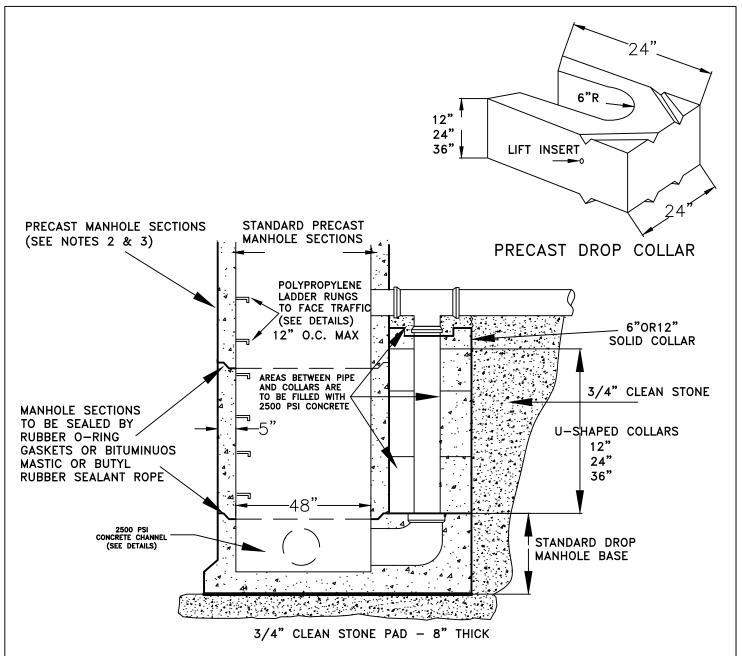

- 1. MANHOLES MUST PASS A VACUUM TEST REQUIRED BY BRANCHBURG TOWNSHIP ENGINEERING DEPARTMENT.
- 2. PRECAST MANHOLES SECTIONS TO BE IN ACCORDANCE WITH ASTM C-478.
- 3. PRECAST MANHOLES SHALL BE SEALED WITH (2) COATS OF AN ACCEPTABLE WATERPROOFING TAR, ASPHALT, WITH ENOUGH TIME ALLOWED BETWEEN THE SEAL COATS TO BOND, OR POLYPLASTIC ALLOY BY THE MANUFACTURER.
- 4. SHOP DRAWINGS SHALL BE SUBMITTED TO THE ENGINEERING DEPARTMENT FOR REVIEW AND APPROVAL.
- 5. PIPE COVERAGE TO FOLLOW THE "SANITARY SEWER TRENCH SECTION" DETAILS.
- 6. A MINIMUM OF 6" OF 3/4" CLEAN STONE SHALL BE USED AS BACKFILL ON ALL SIDES.
- 7. CAMPBELL MANHOLE CASTING NO. 1203 B OR APPROVED EQUAL (SEE DETAILS).


PRECAST CONCRETE DROP MANHOLE

Not to Scale



TOWNSHIP OF BRANCHBURG

1077 Route 202 North Branchburg, New Jersey 08876-3936 TELE: (908)526-1300 FAX: (908)526-2452 STANDARD CONSTRUCTION DETAILS
SANITARY SEWER
PRECAST CONCRETE DROP MANHOLE

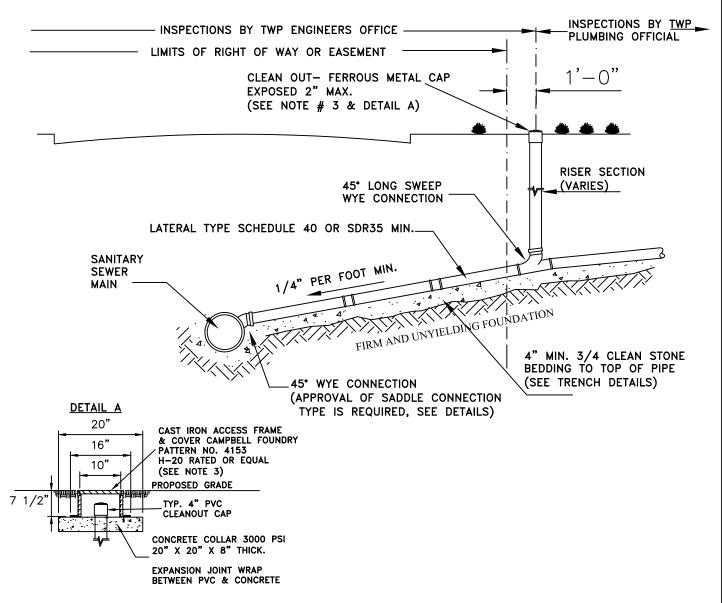

- 1. AN APPLICATION TO OPEN PUBLIC GROUNDS IS REQUIRED BY THE TOWNSHIP OF BRANCHBURG ENGINEERING DEPARTMENT, WHEN WORKING IN THIS AREA.
- 2. REFER TO CODE ENFORCEMENT/BUILDING DEPARTMENT FOR THE REQUIREMENTS FROM THE LATERAL CLEAN OUT TO HOUSE CONNECTION.
- 3. IN AREAS WHERE A REQUIRED CLEAN OUT IS WITHIN A TRAVELED PATH, WALKWAY OR PAVEMENT, A CASTING SHALL BE INSTALLED TO PROTECT THE CLEAN OUT. THE CASTING SHALL HAVE A MINIMUM RATING OF H-20. THE CASTING SHALL BE FLUSH WITH THE GRADE AND A CONCRETE COLLAR/ FOOTING 8 INCHES MINIMUM THICKNESS, CLASS B CONCRETE AND 4 INCHES WIDER THAN THE PROPOSED CASTING BOTTOM FLANGE. IF THE CLEAN-OUT IS LARGER THAN 4 INCHES THEN THE CASTING SHALL BE LARGE ENOUGH TO HAVE CLEARANCE OF AT LEAST 2 INCHES AROUND THE CLEAN-OUT CAP.

LATERAL CONNECTION


Not to Scale



TOWNSHIP OF BRANCHBURG

1077 Route 202 North Branchburg, New Jersey 08876-3936 TELE: (908)526-1300 FAX: (908)526-2452 STANDARD CONSTRUCTION DETAILS
SANITARY SEWER
LATERAL CONNECTION

		-		
DOUGLAS A. BALL,	P.E., TOWNSHIP ENGINEEI	₹		
DATE: 2-1-10	SCALE : NTS	DRAWN BY: JAR	REV: 2018	19

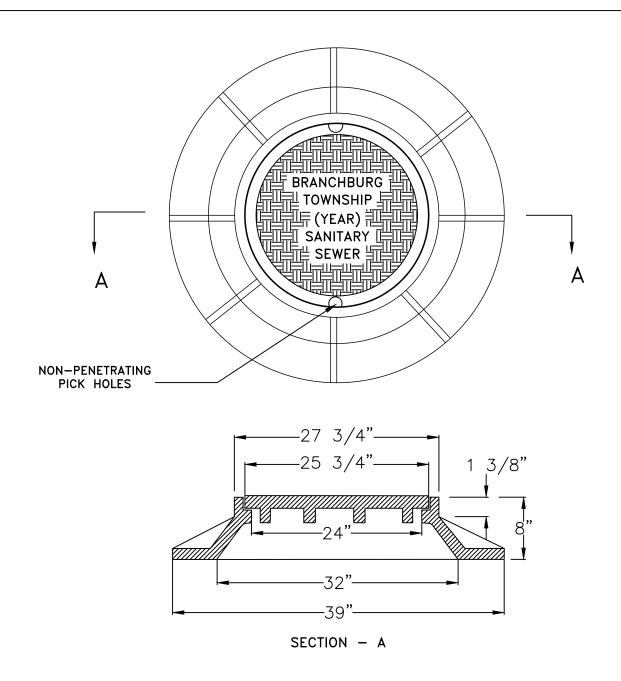

NOTE

- 1. CAMPBELL CASTING MANHOLE CASTING NO. 1203 B OR APPROVED EQUAL, MADE IN AMERICA.
- 2. SHOP DRAWINGS SHALL BE SUBMITTED FOR APPROVALS.

MANHOLE FRAME & COVER


Not to Scale



TOWNSHIP OF BRANCHBURG

1077 Route 202 North Branchburg, New Jersey 08876-3936 TELE: (908)526-1300 FAX: (908)526-2452 STANDARD CONSTRUCTION DETAILS
SANITARY SEWER
MANHOLE FRAME & COVER

DOUGLAS A. BALL, P.E., TOWNSHIP ENGINEER

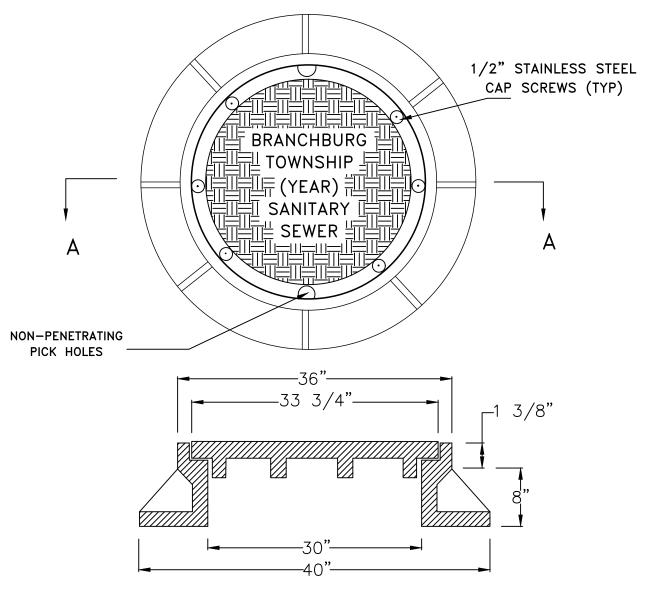

SECTION - A

NOTE:

ALL WATERTIGHT CASTINGS TO BE SUPPLIED WITH:

- 1. MACHINED BEARING SURFACES.
- 2. 1/4" FLAT NEOPRENE GASKETS.
- 3. 1/2" DIA. STAINLESS STEEL CAP SCEWS.
- 4. NON-PENETRATING PICK HOLES.
- 5. CAMPBELL MANHOLE CASTING NO. 1503 OR APPROVED EQUAL, MADE IN AMERICA.
- 6. SHOP DRAWINGS SHALL BE SUBMITTED FOR APPROVALS.

WATERTIGHT MANHOLE FRAME & COVER


Not to Scale



TOWNSHIP OF BRANCHBURG


1077 Route 202 North Branchburg, New Jersey 08876-3936 TELE: (908)526-1300 FAX: (908)526-2452 STANDARD CONSTRUCTION DETAILS
SANITARY SEWER
WATERTIGHT MANHOLE FRAME & COVER

DOUGLAS A. BALL,	P.E., TOWNSHIP ENGINEER	२		
DATE: 2-2-10	SCALE : NTS	DRAWN BY: JAR	REV: 9/2014	21

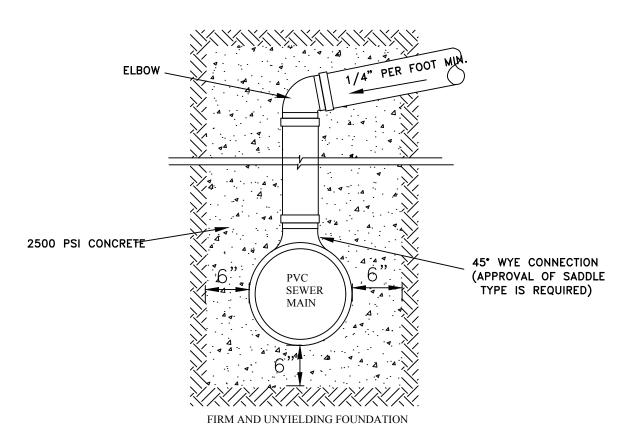

RISER CONNECTION

Not to Scale

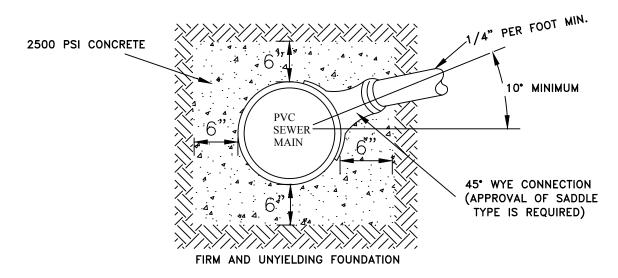

SADDLE CONNECTION

Not to Scale




TOWNSHIP OF BRANCHBURG

1077 Route 202 North Branchburg, New Jersey 08876-3936 TELE: (908)526-1300 FAX: (908)526-2452 STANDARD CONSTRUCTION DETAILS
SANITARY SEWER
RISER/SADDLE CONNECTION

DOUGLAS	Α.	BALL,	P.E.,	TOWNSHIP	ENGINEE	R

DATE: 2-1-10 SCALE : NTS DRAWN BY: JAR 2015 22

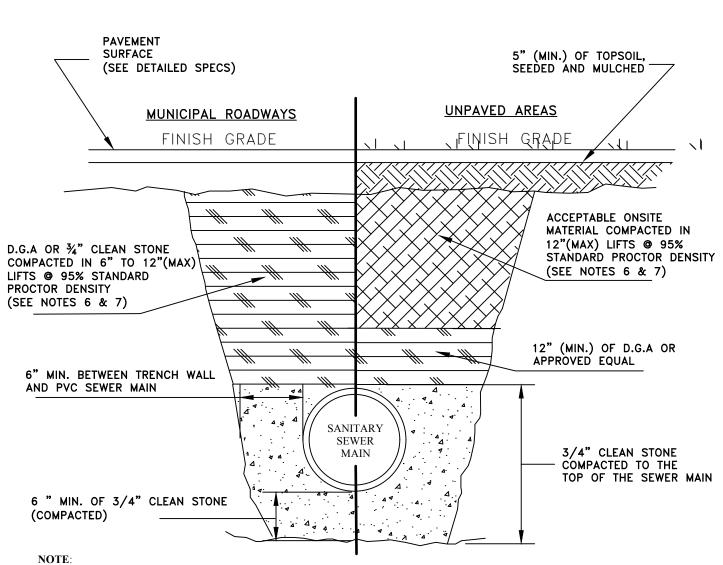

- 1. ALL SEWER MAINS ARE TO BE OF SDR 35 AND CONFORM TO ASTM D3034 OR TOWNSHIP ENGINEERS APPROVAL.
- 2. ALL SEWER MAINS AND LATERALS ARE REQUIRED TO BE PRESSURE TESTED.
- 3. LATERALS ARE TESTED FROM THE MAIN TO THE RIGHT OF WAY.
- 4. THE ENGINEERING DEPARTMENT SHALL PROVIDE A CHECKLIST FOR ALL SANITARY SEWER TESTING.
- 5. A CODE ENFORCEMENT PLUMBING OFFICIAL IS REQUIRED TO TEST AND INSPECT FROM THE RIGHT OF WAY TO THE HOUSE CONNECTION.
- ACCEPTABLE ONSITE MATERIALS TO BE DETERMINED BY THE TOWNSHIP ENGINEER OR REPRESENTATIVES, SHALL COMPLY WITH NJDOT SPECIFICATION: 901.11 SOIL AGGREGATE.
- 7. APPROVED EQUIVALENT MATERIALS REQUIRES TESTING ANALYSIS AND CLEAN FILL CERTIFICATION.

SANITARY SEWER TRENCH SECTION


Not to Scale



TOWNSHIP OF BRANCHBURG

1077 Route 202 North Branchburg, New Jersey 08876-3936 TELE: (908)526-1300 FAX: (908)526-2452 STANDARD CONSTRUCTION DETAILS
SANITARY SEWER TRENCH SECTION

DOUGLAS A. BALL,	P.E., TOWNSHIP ENGINEER	₹		
DATE: 2-1-10	SCALE : NTS	DRAWN BY: JAR	REV: 2018	23

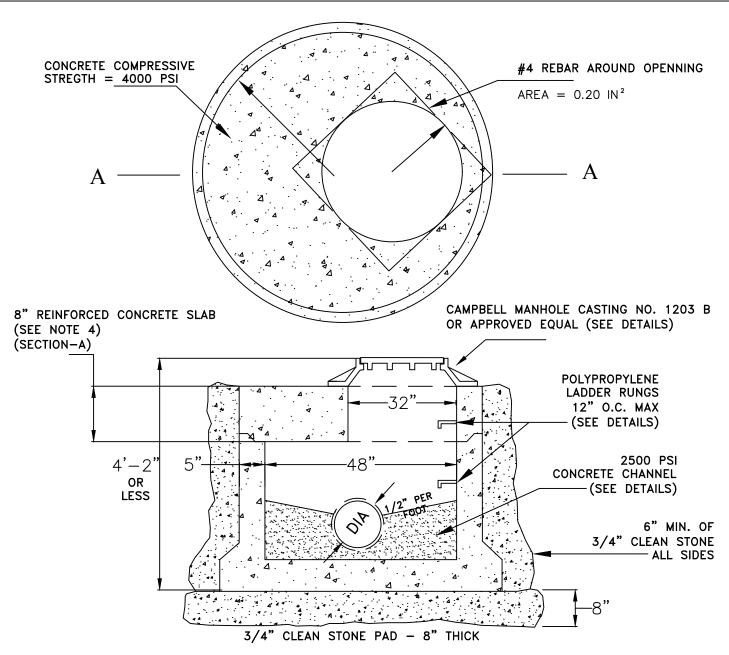

- 1. 12" THICK CONCRETE SLAB (3500 PSI) TO BE SUBSTITUDED FOR STONE BASE WHEN DIRECTED BY THE TOWNSHIP ENGINEER. (ALL MANHOLES)
- 2. PRECAST MANHOLES TO CONFORM TO REQUIREMENTS OF ASTM SPEC. C-478
- 3. PIPE COVERAGE TO FOLLOW THE "STORM SEWER TRENCH SECTION" DETAILS, PROVIDED BY THE BRANCHBURG TOWNSHIP ENGINERING DEPARTMENT;
- 4. SLAB SHALL BE SEALED IN PLACE WITH BUTYL RUBBER SEALANT ROPE OR BITUMINOUS MASTIC ROPE.

PRECAST CONCRETE MANHOLE SLAB

Not to Scale




TOWNSHIP OF BRANCHBURG

1077 Route 202 North Branchburg, New Jersey 08876-3936 TELE: (908)526-1300 FAX: (908)526-2452 STANDARD CONSTRUCTION DETAILS STORM and SANITARY SEWER PRECAST CONCRETE MANHOLE SLAB

DOUGLAS A. BALL, P.E., TOWNSHIP ENGINEER

DATE: 2-2-10 | SCALE : NTS | DRAWN BY: JAR | REV: 9/2014 | 24

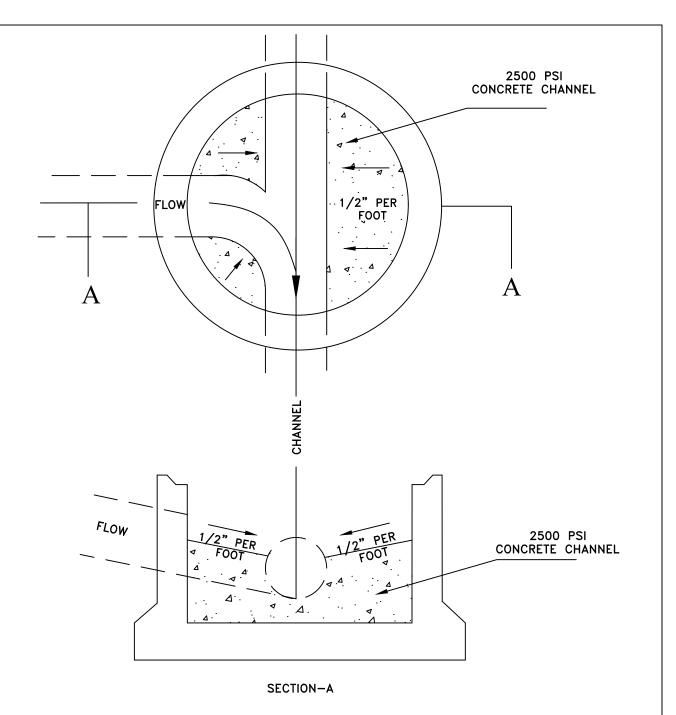

- 1. PRECAST MANHOLES TO CONFORM TO REQUIREMENTS OF ASTM SPEC. C-478.
- 2. PIPE COVERAGE TO FOLLOW THE "STORM SEWER TRENCH SECTION" DETAILS, PROVIDED BY THE BRANCHBURG TOWNSHIP ENGINERING DEPARTMENT.

CONCRETE MANHOLE CHANNEL


Not to Scale




TOWNSHIP OF BRANCHBURG

1077 Route 202 North Branchburg, New Jersey 08876-3936 TELE: (908)526-1300 FAX: (908)526-2452 STANDARD CONSTRUCTION DETAILS STORM and SANITARY SEWER CONCRETE MANHOLE CHANNEL

DOUGLAS A. BALL,	P.E., TOWNSHIP ENGINEER	R		
DATE: 2-2-10	SCALE : NTS	DRAWN BY: JAR	2015	25

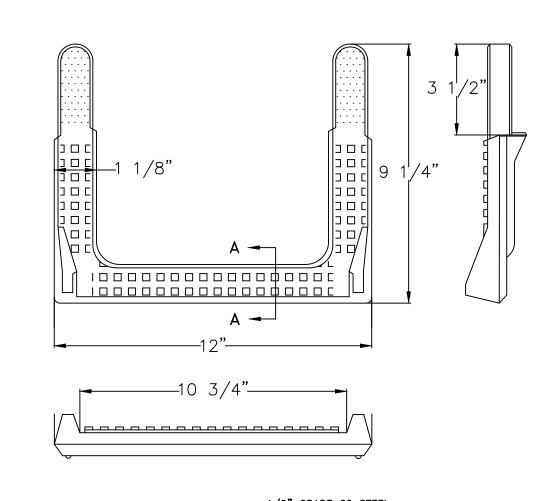

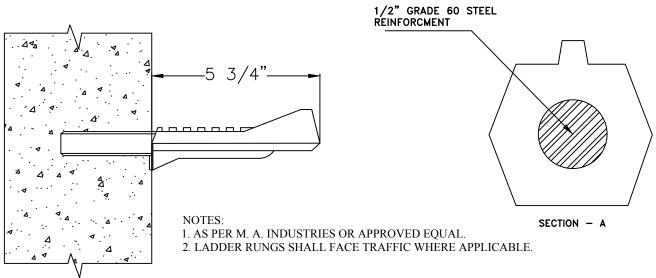

POLYPROPYLENE STEPS


Not to Scale



TOWNSHIP OF BRANCHBURG

1077 Route 202 North Branchburg, New Jersey 08876-3936 TELE: (908)526-1300 FAX: (908)526-2452 STANDARD CONSTRUCTION DETAILS STORM/SANITARY SEWER POLYPROPYLENE STEPS

DOUGLAS A. BALL, P.E., TOWNSHIP ENGINEER

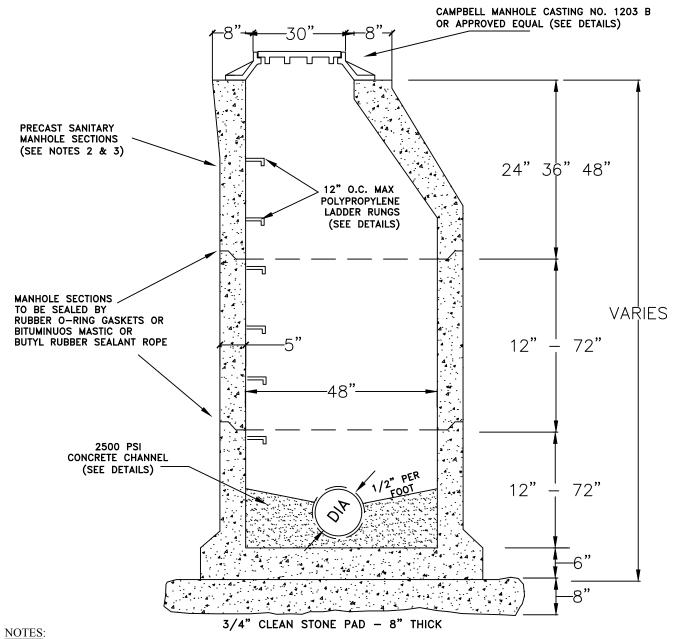

- 1. SANITARY MANHOLES MUST PASS A VACUUM TEST REQUIRED BY BRANCHBURG TOWNSHIP ENGINEERING DEPARTMENT.
- 2. PRECAST MANHOLES SECTIONS TO BE IN ACCORDANCE WITH ASTM C-478.
- 3. SANITARY PRECAST MANHOLES SHALL BE SEALED WITH (2) COATS OF AN ACCEPTABLE WATERPROOFING TAR, ASPHALT, WITH ENOUGH TIME ALLOWED BETWEEN THE SEAL COATS TO BOND, OR POLYPLASTIC ALLOY BY THE MANUFACTURER.
- 4. SHOP DRAWINGS SHALL BE SUBMITTED TO THE ENGINEERING DEPARTMENT FOR REVIEW AND APPROVAL.
- 5. PIPE COVERAGE TO FOLLOW THE "SANITARY OR STORM SEWER TRENCH SECTION" DETAILS.
- 6. A MINIMUM OF 6" OF 3/4" CLEAN STONE SHALL BE USED AS BACKFILL ON ALL SIDES.
- 7. CAMPBELL MANHOLE CASTING NO. 1203 B OR APPROVED EQUAL (SEE DETAILS).

PRECAST CONCRETE MANHOLE

Not to Scale




TOWNSHIP OF BRANCHBURG

1077 Route 202 North Branchburg, New Jersey 08876-3936 TELE: (908)526-1300 FAX: (908)526-2452 STANDARD CONSTRUCTION DETAILS STORM and SANITARY SEWER PRECAST CONCRETE MANHOLE

DOUGLAS A. BALL, P.E., TOWNSHIP ENGINEER

DATE: 2-1-10 | SCALE : NTS | DRAWN BY: JAR | REV: 9/2014 | 27

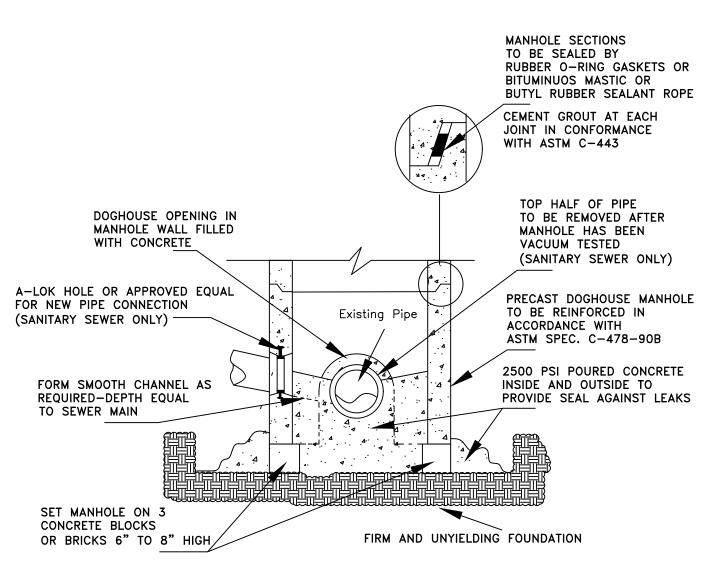

- 1. 12" THICK CONCRETE SLAB (3500 PSI) TO BE SUBSTITUTED FOR STONE BASE WHEN DIRECTED BY THE TOWNSHIP ENGINEER. (ALL MANHOLES)
- 2. PRECAST MANHOLES TO CONFORM TO REQUIREMENTS OF ASTM SPEC. C-478.
- 3. PIPE COVERAGE TO FOLLOW THE "SANITARY SEWER TRENCH SECTION" DETAILS.
- 4. CAMPBELL MANHOLE CASTING NO. 1203 B OR APPROVED EQUAL (SEE DETAILS).
- 5. SANITARY SEWER MANHOLES MUST PASS A VACUUM TEST, A SANITARY SEWER TEST CHECKLIST SHALL BE PROVIDED BY BRANCHBURG TOWNSHIP ENGINEERING DEPARTMENT.
- 6. SHOP DRAWINGS SHALL BE SUBMITTED TO THE ENGINEERING DEPARTMENT FOR REVIEW AND APPROVALS.

PRECAST DOGHOUSE MANHOLE

Not to Scale




TOWNSHIP OF BRANCHBURG

1077 Route 202 North Branchburg, New Jersey 08876-3936 TELE: (908)526-1300 FAX: (908)526-2452 STANDARD CONSTRUCTION DETAILS SANITARY AND STORM SEWERS PRECAST DOGHOUSE MANHOLE

DOUGLAS A. BALL, P.E., TOWNSHIP ENGINEER

DATE: 2-1-10 SCALE : NTS DRAWN BY: JAR REV: 9/2014 28

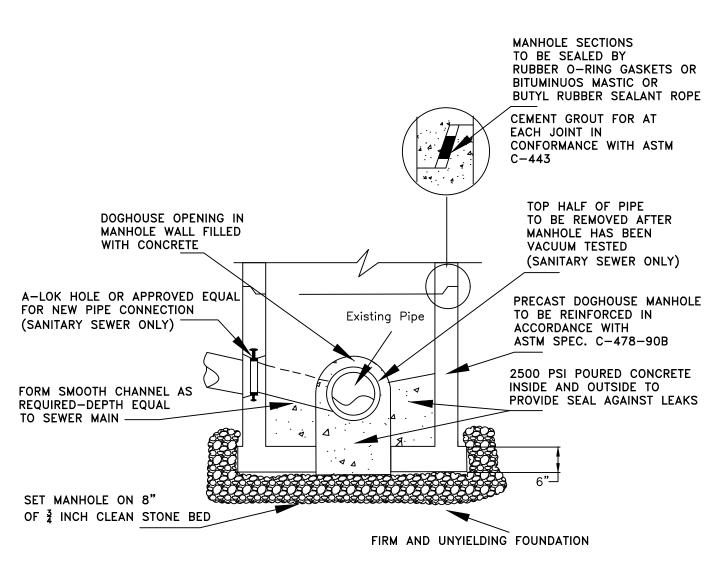

- 1. 12" THICK CONCRETE SLAB (3500 PSI) TO BE SUBSTITUTED FOR STONE BASE WHEN DIRECTED BY THE TOWNSHIP ENGINEER. (ALL MANHOLES)
- 2. PRECAST MANHOLES TO CONFORM TO REQUIREMENTS OF ASTM SPEC. C-478.
- 3. PIPE COVERAGE TO FOLLOW THE "SANITARY SEWER TRENCH SECTION" DETAILS.
- 4. CAMPBELL MANHOLE CASTING NO. 1203 B OR APPROVED EQUAL (SEE DETAILS).
- 5. SANITARY SEWER MANHOLES MUST PASS A VACUUM TEST, A SANITARY SEWER TEST CHECKLIST SHALL BE PROVIDED BY BRANCHBURG TOWNSHIP ENGINEERING DEPARTMENT.
- 6. SHOP DRAWINGS SHALL BE SUBMITTED TO THE ENGINEERING DEPARTMENT FOR REVIEW AND APPROVALS.

PRECAST DOGHOUSE MANHOLE WITH BASE Not to Scale





TOWNSHIP OF BRANCHBURG

1077 Route 202 North Branchburg, New Jersey 08876-3936 TELE: (908)526-1300 FAX: (908)526-2452 STANDARD CONSTRUCTION DETAILS SANITARY AND STORM SEWERS PRECAST DOGHOUSE MANHOLE WITH BASE

DOUGLAS A. BALL, P.E., TOWNSHIP ENGINEER

DATE: 1-23-14 SCALE : NTS DRAWN BY: JAR REV: 2018

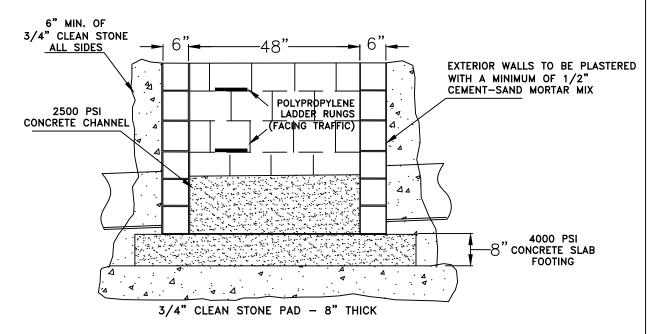

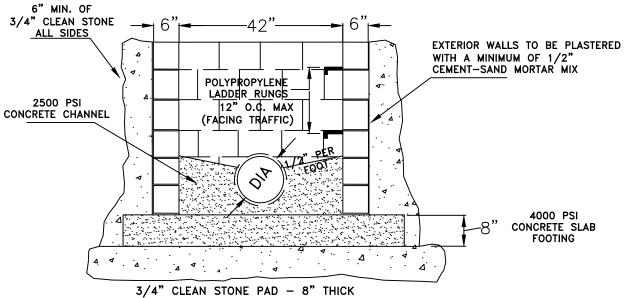

- 1. PRECAST INLETS TO CONFORM TO REQUIREMENTS OF ASTM SPEC. C-478.
- 2. PIPE COVERAGE TO FOLLOW THE "STORM SEWER TRENCH SECTION" DETAILS.
- 3. FRAME AND GRATE TO BE #2618 TYPE "N" OR "P2" ECO CURB PIECE AS MANUFACTURED BY CAMPBELL FOUNDRY CO. OR APPROVED EQUAL; MADE IN AMERICA PRODUCTS, BICYCLE SAFE GRATES SHALL BE USED. (SEE DETAILS)

CONCRETE BLOCK INLET


Not to Scale




TOWNSHIP OF BRANCHBURG

1077 Route 202 North Branchburg, New Jersey 08876-3936 TELE: (908)526-1300 FAX: (908)526-2452 STANDARD CONSTRUCTION DETAILS
STORM SEWER
CONCRETE BLOCK INLETS

DOUGLAS A. BALL,	P.E., TOWNSHIP ENGINEEI			
DATE: 2-1-10	SCALE : NTS	DRAWN BY: JAR	2015	29

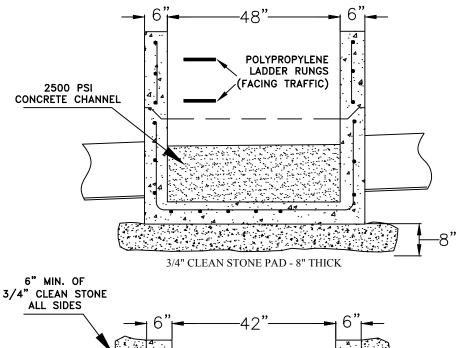

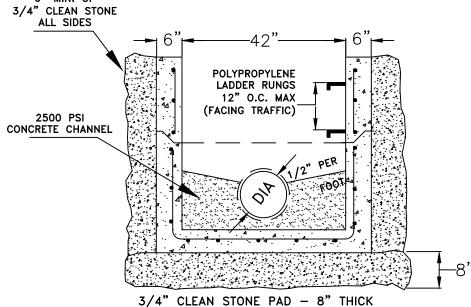

- 1. PRECAST INLETS TO CONFORM TO REQUIREMENTS OF ASTM SPEC. C-478.
- 2. PIPE COVERAGE TO FOLLOW THE "STORM SEWER TRENCH SECTION" DETAILS.
- 3. FRAME AND GRATE TO BE #2618 TYPE "N" OR "P2" ECO CURB PIECE AS MANUFACTURED BY CAMPBELL FOUNDRY CO. OR APPROVED EQUAL; MADE IN AMERICA PRODUCTS, BICYCLE SAFE GRATES SHALL BE USED. (SEE DETAILS)
- 4. SHOP DRAWINGS SHALL BE SUBMITTED TO THE ENGINEERING DEPARTMENT FOR REVIEW AND APPROVALS.

PRECAST CONCRETE INLET

Not to Scale




TOWNSHIP OF BRANCHBURG

1077 Route 202 North Branchburg, New Jersey 08876-3936 TELE: (908)526-1300 FAX: (908)526-2452 STANDARD CONSTRUCTION DETAILS
STORM SEWER
PRECAST CONCRETE INLETS


DOUGLAS A. BALL, P.E., TOWNSHIP ENGINEER

DATE: 2-2-10 SCALE : NTS DRAWN BY: JAR 2015 30

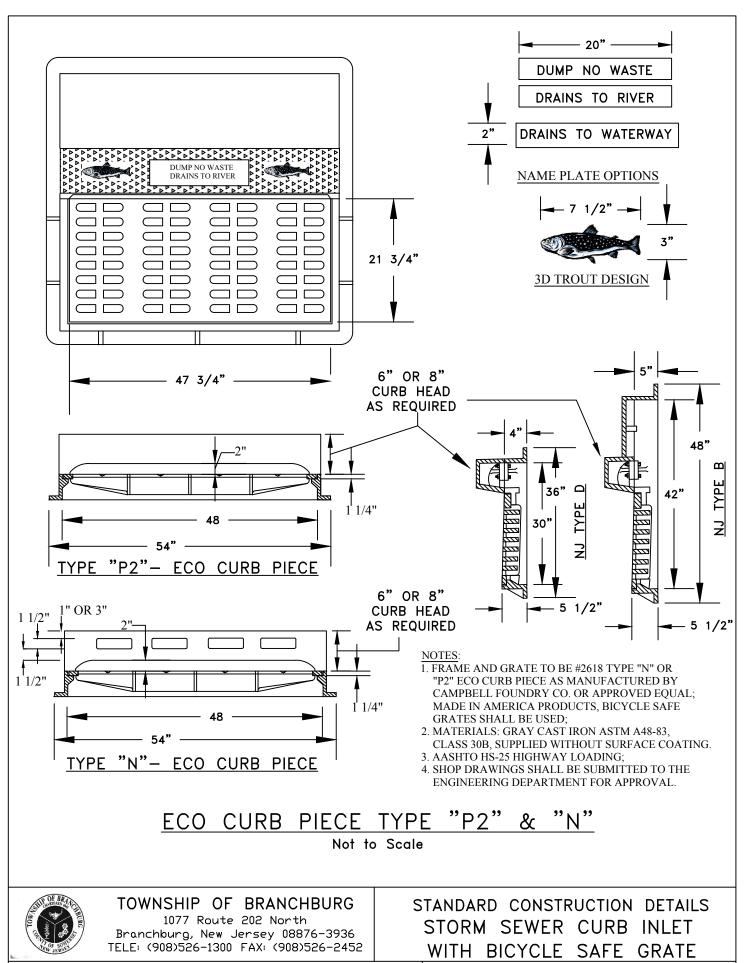

DOUGLAS A. BALL, P.E., TOWNSHIP ENGINEER

DATE: 2-2-10 SCALE: NTS DRAWN BY: JAR REV: 2015 31

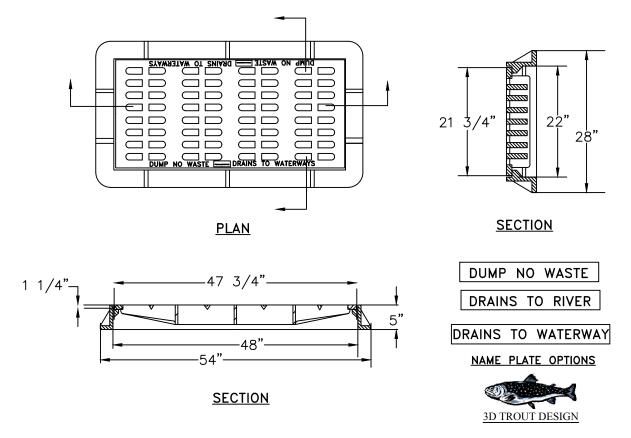

- 1. FRAME CAMPBELL FOUNDRY NO. 3405 OR APPROVED EQUAL, MADE IN AMERICA PRODUCTS.
- 2. ECO BICYCLE SAFE GRATE CAMPELL FOUNDRY NO. 2617.
- 3. MATERIALS: GRAY CAST IRN ASTM A48-83, CLASS 30B, CASTINGS SUPPLIED WITHOUT COATING.
- 4. LOADING: AASHTO HS-25 HIGHWAY LOADING.
- 5. SHOP DRAWING SHALL BE SUBMITTED TO THE ENGINEERING DEPARTMENT FOR APPROVAL.

TYPE "A" INLET ECO BICYCLE SAFE GRATE


Not to Scale



TOWNSHIP OF BRANCHBURG

1077 Route 202 North Branchburg, New Jersey 08876-3936 TELE: (908)526-1300 FAX: (908)526-2452 STANDARD CONSTRUCTION DETAILS
STORM SEWER
TYPE "A" INLET

DOUGLAS A. BALL,	P.E., TOWNSHIP ENGINEE	R		
DATE: 2-2-10	SCALE : NTS	DRAWN BY: JAR	REV: 9/2014	32

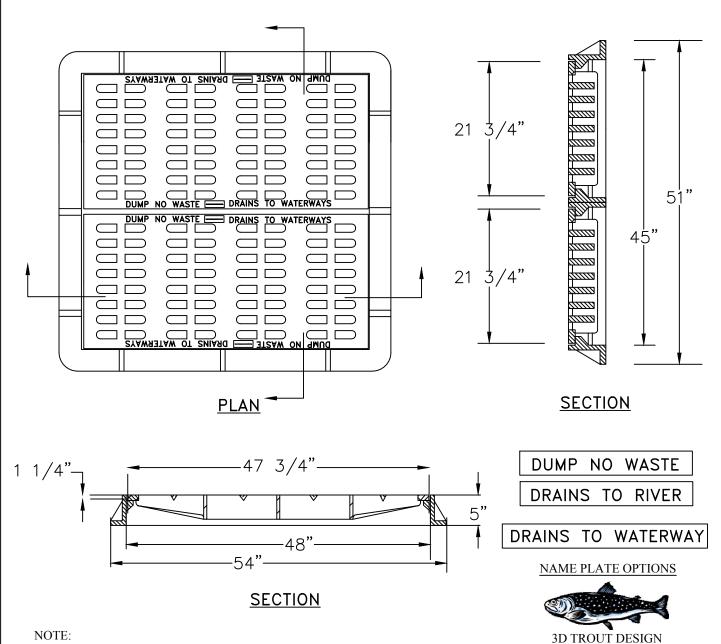

- FRAME CAMPBELL FOUNDRY NO. 3425 OR APPROVED EQUAL. MADE IN AMERICA PRODUCTS.
- 2. ECO BICYCLE SAFE GRATE CAMPELL FOUNDRY NO. 2617
- 3. MATERIALS: GRAY CAST IRON ASTM A48-83, CLASS 30B, CASTINGS SUPPLIED WITHOUT COATING.
- 4. LOADING: AASHTO HS-25 HIGHWAY LOADING.
- 5. SHOP DRAWINGS SHALL BE SUBMITTED TO THE ENGINEERING DEPARTMENT FOR APPROVALS.

TYPE "E" INLET ECO BICYCLE SAFE GRATES

Not to Scale




TOWNSHIP OF BRANCHBURG

1077 Route 202 North Branchburg, New Jersey 08876-3936 TELE: (908)526-1300 FAX: (908)526-2452 STANDARD CONSTRUCTION DETAILS
STORM SEWER
ECO TYPE "E" INLET

DOUGLAS A. BALL, P.E., TOWNSHIP ENGINEER

DATE: 2-2-10 | SCALE: NTS | DRAWN BY: JAR | REV: 9/2014 | 33

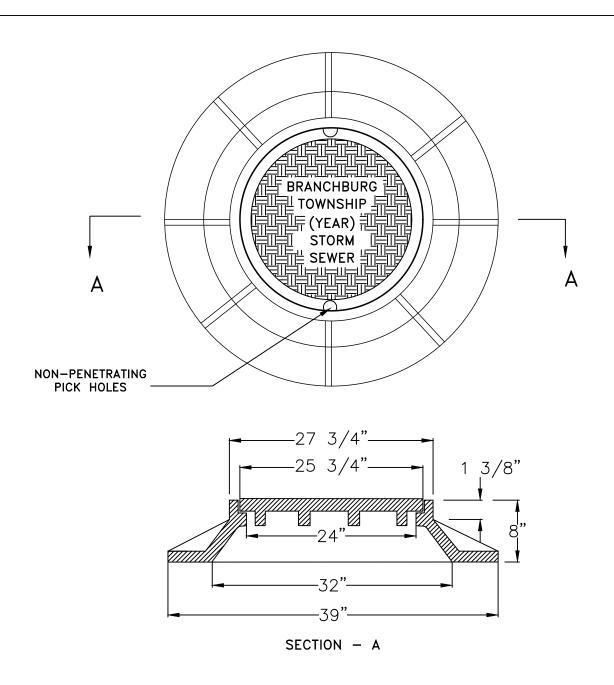

NOTE

- 1. CAMPBELL CASTING MANHOLE CASTING NO. 1203 B OR APPROVED EQUAL, MADE IN AMERICA.
- 2. SHOP DRAWINGS SHALL BE SUBMITTED FOR APPROVALS.

MANHOLE FRAME & COVER


Not to Scale



TOWNSHIP OF BRANCHBURG

1077 Route 202 North Branchburg, New Jersey 08876-3936 TELE: (908)526-1300 FAX: (908)526-2452 STANDARD CONSTRUCTION DETAILS
STORM SEWER
MANHOLE FRAME & COVER

DOUGLAS A. BALL,	P.E., TOWNSHIP ENGINEER	R		
DATE: 2-2-10	SCALE : NTS	DRAWN BY: JAR	REV: 9/2014	34

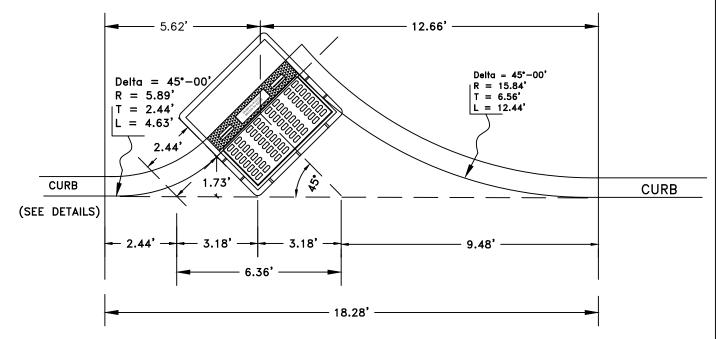

TO BE INSTALLED WHERE ROAD GRADE EXCEEDS 4.5%

- 1. FRAME AND GRATE TO BE #2618 TYPE "N" OR "P2" ECO CURB PIECE AS MANUFACTURED BY CAMPBELL FOUNDRY CO. OR APPROVED EQUAL; MADE IN AMERICA PRODUCTS, BICYCLE SAFE GRATES SHALL BE USED. (SEE DETAILS)
- 2. MATERIALS: GRAY CAST IRON ASTM A48-83, CLASS 30B, SUPPLIED WITHOUT SURFACE COATING.
- 3. AASHTO HS-25 HIGHWAY LOADING;
- 4. SHOP DRAWINGS SHALL BE SUBMITTED TO THE ENGINEERING DEPARTMENT FOR APPROVAL.
- 5. ROADWAYS GREATER THAN 4.5%, SHALL HAVE ANGLED INLETS.

45° CURB INLET SETTING


Not to Scale



TOWNSHIP OF BRANCHBURG

1077 Route 202 North Branchburg, New Jersey 08876-3936 TELE: (908)526-1300 FAX: (908)526-2452 STANDARD CONSTRUCTION DETAILS
STORM SEWER
45° CURB INLET SETTING

DOUGLAS A. BALL,	P.E., TOWNSHIP ENGINEE	R		
DATE: 2-1-10	SCALE : NTS	DRAWN BY: JAR	REV: 2018	35

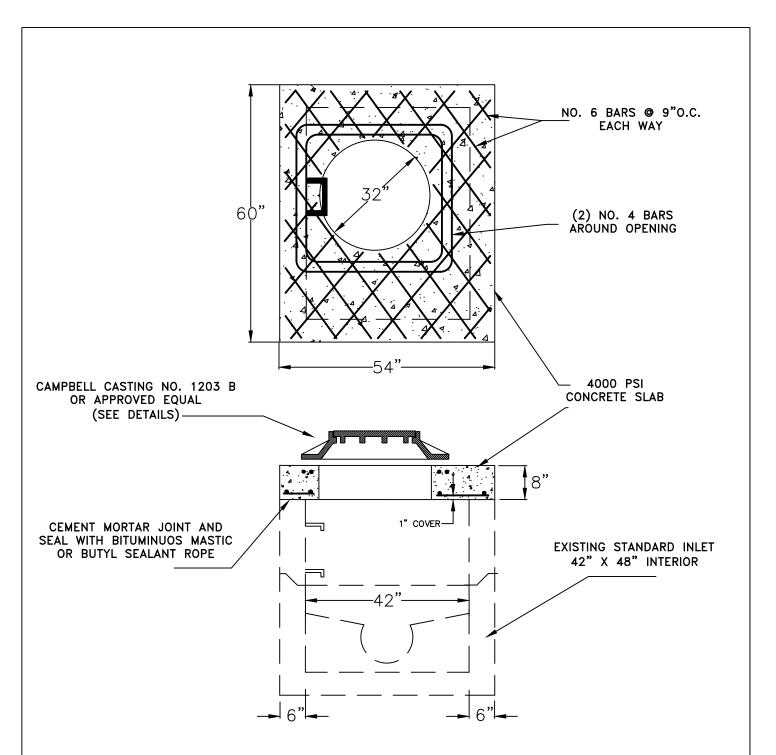

NOTE: SHOP DRAWINGS SHALL BE SUBMITTED TO THE ENGINEERING DEPARTMENT FOR REVIEW AND APPROVALS.

CONCRETE INLET TO MANHOLE CONVERSION Not to Scale





TOWNSHIP OF BRANCHBURG

1077 Route 202 North Branchburg, New Jersey 08876-3936 TELE: (908)526-1300 FAX: (908)526-2452 STANDARD CONSTRUCTION DETAILS
STORM SEWER
INLET TO MANHOLE CONVERSION

DOUGLAS A. BALL, P.E., TOWNSHIP ENGINEER

DATE: 2-2-10 SCALE : NTS DRAWN BY: JAR REV: 9/2014 36

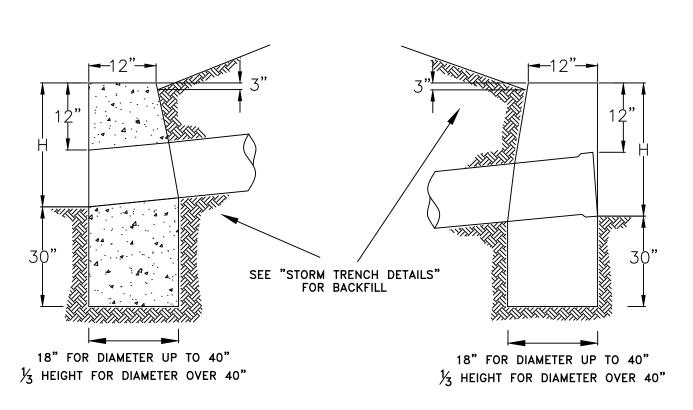

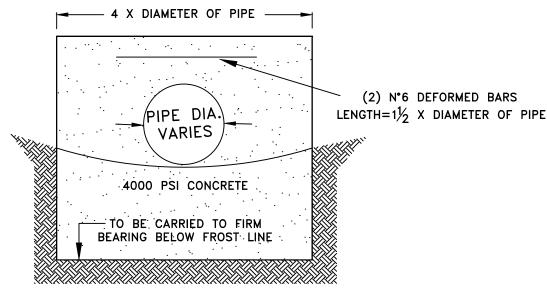

- 1. SCOUR PROTECTION AS DEEMED NECESSARY BY THE TOWNSHIP ENGINEER.
- 2. SHOP DRAWING SHALL BE SUBMITTED TO THE ENGINEERING DEPARTMENT FOR REIEW AND APPROVAL.

STANDARD CONCRETE HEADWALL

Not to Scale




TOWNSHIP OF BRANCHBURG

1077 Route 202 North Branchburg, New Jersey 08876-3936 TELE: (908)526-1300 FAX: (908)526-2452 STANDARD CONSTRUCTION DETAILS
STORM SEWER
STANDARD CONCRETE HEADWALL

DOUGLAS A. BALL, P.E., TOWNSHIP ENGINEER

DATE: 2-2-10 SCALE : NTS DRAWN BY: JAR REV: 9/2014 37

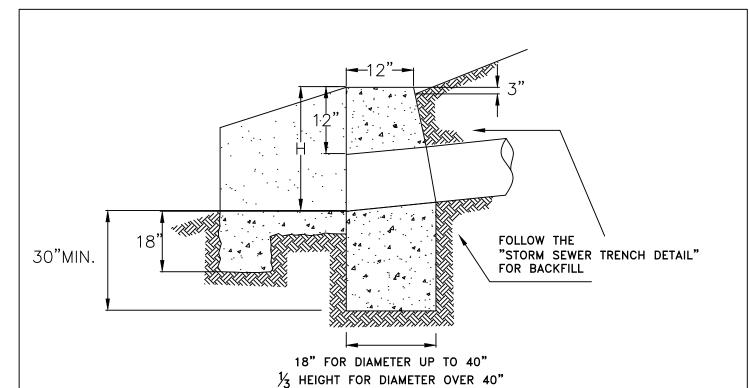

(2) N°6 DEFORMED BARS

LENGTH=1½ X DIAMETER OF PIPE

CONCRETE APRON
6" THICK

TO BE CARRIED TO FIRM
BEARING BELOW FROST LINE

NOTE:

- 1. SCOUR PROTECTION AS DEEMED NECESSARY BY THE TOWNSHIP ENGINEER.
- 2. SHOP DRAWINGS SHALL BE SUBMITTED TO THE ENGINEERING DEPARTMENT FOR REVIEW AND APPROVAL.

STANDARD CONCRETE WINGED HEADWALL

Not to Scale




TOWNSHIP OF BRANCHBURG

1077 Route 202 North Branchburg, New Jersey 08876-3936 TELE: (908)526-1300 FAX: (908)526-2452 STANDARD CONSTRUCTION DETAILS
STORM SEWER
STANDARD WINGED HEADWALL

DOUGLAS A. BALL, P.E., TOWNSHIP ENGINEER

DATE: 2-2-10 SCALE : NTS DRAWN BY: JAR REV: 9/2014 38

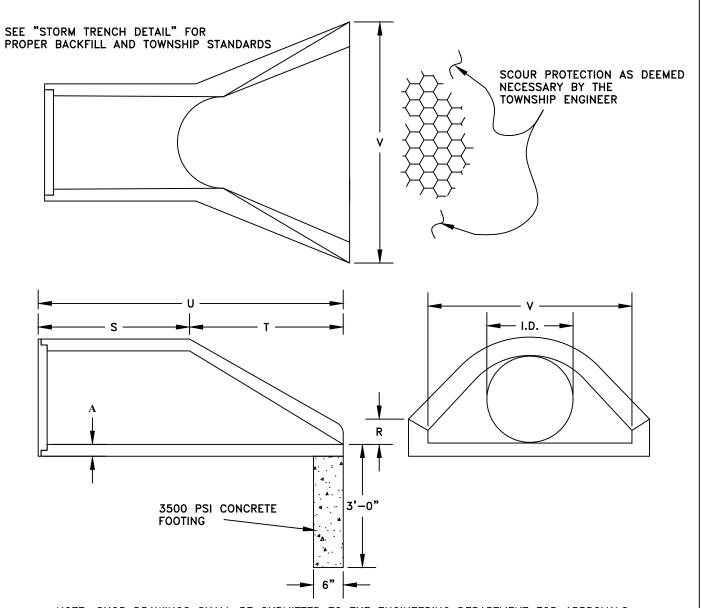

NOTE: SHOP DRAWINGS SHALL BE SUBMITTED TO THE ENGINEERING DEPARTMENT FOR APPROVALS.

	F(OR 30" [DIAMETER	PIPE O	R LESS		
I.D.	12	15	18	21	24	27	30
A	2	2 1/4	2 1/2	2 3/4	3	3 1/4	3 1/2
R	5	7 1/2	9	9	10	10	14
S	24	24	24	24	24	24	26
T	24	24	24	24	24	24	30
U	4'	4'	4'	4'	4'	4'	4'-8"
V	24	28	34	40	48	54	60

Flared End Section

Not to Scale




TOWNSHIP OF BRANCHBURG

1077 Route 202 North Branchburg, New Jersey 08876-3936 TELE: (908)526-1300 FAX: (908)526-2452 STANDARD CONSTRUCTION DETAILS
STORM SEWER
FLARED END SECTION

DOUGLAS A. BALL, P.E., TOWNSHIP ENGINEER

DATE: 2-1-10 SCALE: NTS DRAWN BY: JAR REV: 2018

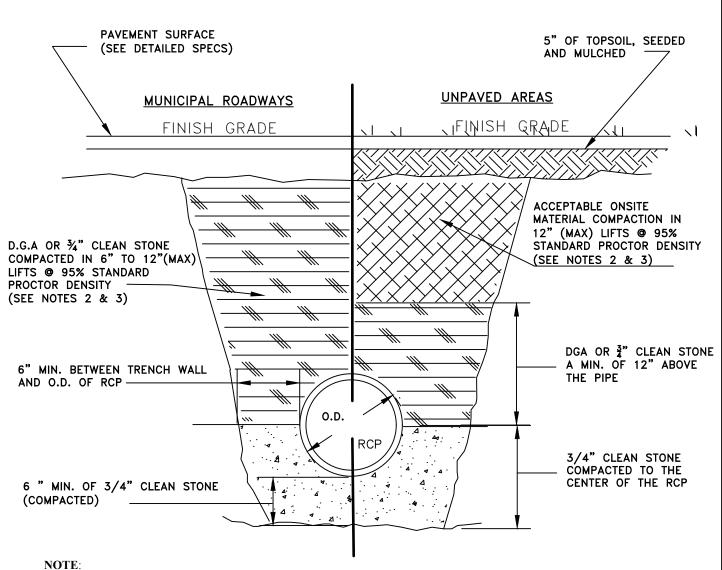

- 1. AN APPLICATION TO OPEN PUBLIC GROUNDS MAY BE REQUIRED BY THE BRANCHBURG TOWNSHIP ENGINEERING DEPARTMENT.
- 2. APPROVED EQUIVALENT MATERIALS REQUIRE TESTING ANALYSIS AND CLEAN FILL CERTIFICATION.
- 3. ACCEPTABLE ONSITE MATERIALS TO BE DETERMINED BY THE TOWNSHIP ENGINEER OR REPRESENTATIVES, SHALL COMPLY WITH NJDOT SPECIFICATIONS: 901.11. SOIL AGGREGATE.
- 4. ALL JOINTS ARE TO BE CEMENT MORTARED 2/3 AROUND THE TOP PERIMETER OF THE PIPE.


STORM SEWER TRENCH SECTION

Not to Scale



TOWNSHIP OF BRANCHBURG

1077 Route 202 North Branchburg, New Jersey 08876-3936 TELE: (908)526-1300 FAX: (908)526-2452 STANDARD CONSTRUCTION DETAILS
STORM SEWER TRENCH SECTION

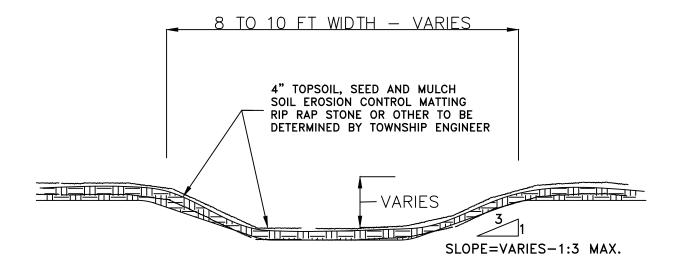

PARABOLIC SWALE - VARIABLE SLOPED SIDES

NOTE:


- 1. AN APPLICATION TO OPEN PUBLIC GROUNDS MAY BE REQUIRED BY THE BRANCHBURG TOWNSHIP ENGINEERING DEPARTMENT.
- 2. CUT SHEETS AND GRADING PLANS MAY BE REQUIRED FOR REVIEW BY THE TOWNSHIP ENGINEER.

GRASS DRAINAGE SWALE (TYP.) Not to Scale



TOWNSHIP OF BRANCHBURG

1077 Route 202 North Branchburg, New Jersey 08876-3936 TELE: (908)526-1300 FAX: (908)526-2452 STANDARD CONSTRUCTION DETAILS STORM SEWER GRASS DRAINAGE SWALE (TYP.)

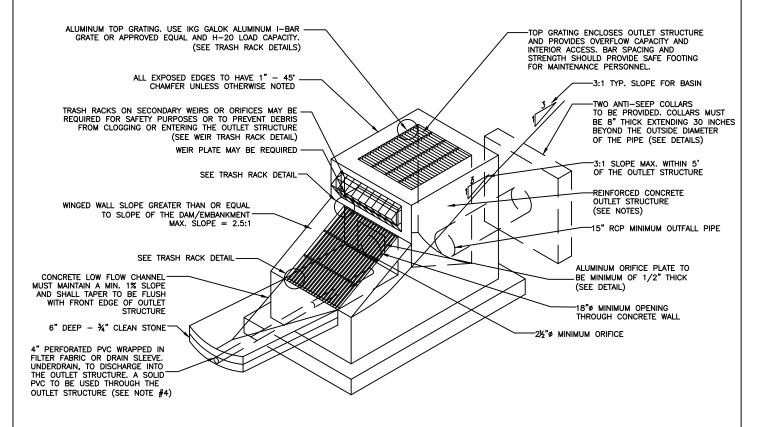

- ALL PIPES, STRUCTURES AND DESIGN SHALL ADHERE TO THE "RESIDENTAIL SITE IMPROVEMENT STANDARD", SUBCHAPTER 7
 STORMWATER MANAGMENT.
- VELOCITIES IN OPEN CHANNELS, EXCLUDING WATER QUALITY SWALE, AT DESIGN FLOW SHALL NOT BE LESS THAN 0.5 FOOT PER SECOND AND NOT GREATER THAN A VELOCITY THAT WILL CAUSE EROSION OR SCOURING OF THE CHANNEL. DESIGN ENGINNERS SHALL DETERMINE PERMISSIBLE VELOCITIES FOR SWALES, OPEN CHANNELS AND DITCHES USING METHODS PRESENTED IN "STANDARDS FOR SOIL EROSION AND SEDIMENT CONTROL IN NEW JERSEY" AT N.J.A.C. 2:90.
- 3. VELOCITIES IN CLOSED CONDUITS AT DESIGN FLOW SHALL BE AT LEAST TWO FEET PER SECOND, BUT NOT MORE THAN THE VELOCITY THAT WILL CAUSE EROSION DAMAGE TO THE CONDUIT, PER THE MANUFACTURER'S SPECIFICATION. MINIMUM ALLOWABLE PIPE SLOPES SHALL PRODUCE VELOCITY OF AT LEAST THREE FEET PER SECOND WHEN THE FLOW DEPTH IS FULL OR HALF THE PIPE DIAMETER.
- 4. WHERE APPLICABLE (INFILTRATION BASINS), A 4" PERFORATED UNDERDRAIN WITH DRAIN SLEEVE, FILTER FABRIC OR SOCK SHALL BE INSTALLED 6" IN THE SAND BED.
- 5. SHOP DRAWINGS SHALL BE SUBMITTED TO THE ENGINEERING DEPARTMENT FOR REVIEW AND APPROVALS.


OUTLET STRUCTURE

Not to Scale



TOWNSHIP OF BRANCHBURG

1077 Route 202 North Branchburg, New Jersey 08876-3936 TELE: (908)526-1300 FAX: (908)526-2452 STANDARD CONSTRUCTION DETAILS
STORM SEWERS
OUTLET STRUCTURE/DETENTION FACILITY

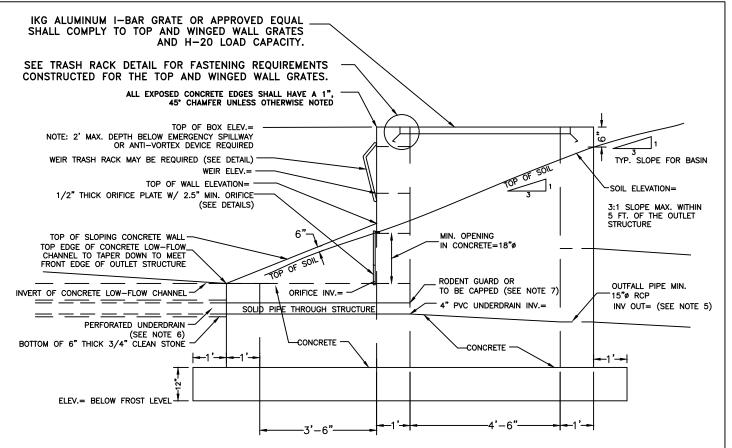

- ALL PIPES, STRUCTURES AND DESIGN SHALL ADHERE TO THE "RESIDENTAIL SITE IMPROVEMENT STANDARD", SUBCHAPTER 7 STORMWATER MANAGEMENT
- IN GENERAL, NO PIPE SIZE IN THE STORM DRAINAGE SYSTEM SHALL BE LESS THAN 15" IN DIAMETER. DESIGN ENGINEERS MAY USE A 12" DIAMETER PIPE AS A CROSS-DRAIN TO A SINGLE INLET.
- 3. THE AVERAGE VELOCITY OF FLOW THROUGH A CLEAN TRASH RACK IS NOT TO EXCEED 2.5 FEET PER SECOND UNDER FULL RANGE OF STAGE AND DISCHARGE. VELOCITY IS TO BE COMPUTED ON THE BASIS OF THE NET AREA OF OPENNING THROUGH THE RACK
- 4. TRASH RACKS AND OVERFLOW GRATES SHALL BE CONSTRUCTED AND INSTALLED TO BE RIGID, DURABLE AND CORROSION RESISTANT, AND SHALLBE DESIGN TO WITHSTAND A PERPENDICULAR LIVE LOADING OF 300 POUNDS PER SQUARE FOOT.
- OUTFALL PIPE ELEVATION SHALL BE LOWER THAN THE PERFORATED PIPE INVERT ELEVATION UNDER THE LOW FLOW CHANNEL; OR SUCH THAT AN UNDERDRAIN FOR A RECHARGE BASIN CAN BE ACCOMIDATED IN THE FUTURE.
- WHERE APPLICABLE (INFILTRATION BASINS), A 4" PERFORATED PVC UNDERDRAIN WITH DRAIN SLEEVE, FILTER FABRIC OR SOCK SHALL BE INSTALLED 6" IN THE SAND BED.
- 7. IF THE DESIGN REQUIRES AN OPEN END THEN A RODENT GUARD SHALL BE INSTALLED. IF THE DESIGN REQUIRES THE END TO BE CLOSED OFF THEN A REMOVABLE CAP SHALL BE INSTALLED IN SOME CASES A BALL VALVE WITH A RODENT GUARD CAN BE APPLIED..

OUTLET STRUCTURE


Not to Scale



TOWNSHIP OF BRANCHBURG

1077 Route 202 North Branchburg, New Jersey 08876-3936 TELE: (908)526-1300 FAX: (908)526-2452 STANDARD CONSTRUCTION DETAILS
STORM SEWERS
OUTLET STRUCTURE/DETENTION FACILITY

DOUGLAS A. BALL,	P.E., TOWNSHIP ENGINEER	К		
DATE: 2-1-10	SCALE : NTS	DRAWN BY: JAR	REV. 2015	42B

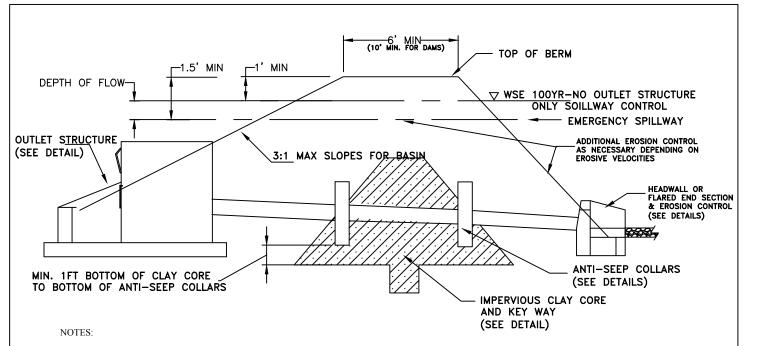

- SITE PLANS SHALL PROVIDE THE LIMITS OF THE CLAY CORE: FOR EMBANKMENT OR BERM THE LIMITS SHALL BE FOR THE FULL LENGTH OF THE BERM. FOR A RECESSED THE LIMITS SHALL BE 40 FEET O.C. OF THE OUTLET PIPE. CUT SHEETS SHALL BE SUBMITTED TO THE ENGINEERING DEPARTMENT FOR REVIEW. THE TIME OF CONSTRUCTION THE BERM SHALL BE CONSTRUCTED 5% HIGHER TO ALLOW FOR SETTLEMENT.
- ALL PIPES, STRUCTURES AND DESIGN SHALL ADHERE TO THE "RESIDENTAIL SITE IMPROVEMENT STANDARD" SUBCHAPTER 7 STORMWATER MANAGMENT
- 3. VELOCITIES IN OPEN CHANNELS, EXCLUDING WATER QUALITY SWALE, AT DESIGN FLOW SHALL NOT BE LESS THAN 0.5 FOOT PER SECOND AND NOT GREATER THAN A VELOCITY THAT WILL CAUSE EROSION OR SCOURING OF THE CHANNEL. DESIGN ENGINNERS SHALL DETERMINE PERMISSIBLE VELOCITIES FOR SWALES, OPEN CHANNELS AND DITCHES USING METHODS PRESENTED IN "STANDARDS FOR SOIL EROSION AND SEDIMENT CONTROL IN NEW JERSEY" AT N.J.A.C. 2:90.
- 4. VELOCITIES IN CLOSED CONDUITS AT DESIGN FLOW SHALL BE AT LEAST TWO FEET PER SECOND, BUT NOT MORE THAN THE VELOCITY THAT WILL CAUSE EROSION DAMAGE TO THE CONDUIT, PER THE MANUFACTURER'S SPECIFICATION. MINIMUM ALLOWABLE PIPE SLOPES SHALL PRODUCE VELOCITY OF AT LEAST THREE FEET PER SECOND WHEN THE FLOW DEPTH IS FULL OR HALF THE PIPE DIAMETER.
- 5. IN GENERAL, NO PIPE SIZE IN THE STORM DRAINAGE SYSTEM SHALL BE LESS THAN 15" IN DIAMETER. DESIGN ENGINEERS MAY USE A 12" DIAMETER PIPE AS A CROSS-DRAIN TO A SINGLE INLET.
- 6. EIGHT INCH THICK ANTI-SEEP COLLARS ARE TO BE INSTALLED ALONG OUTLET PIPES WHEN REQUIRED BY THE MUNICIPAL ENGINEER. REINFORCEMENT STEEL SHALL BE NO. 5 BARS AT 12 INCHES BOTH WAYS, WITH TWO INCHES OF COVER ON BOTH. ALL EXCAVATION FOR THE INSTALLATION OF THE ANTI-SEEP COLLARS SHALL BE BACKFILLED WITH THE APPROVED IMPERVIOUS CLAY.
- 7. MAXIMUM VELOCITIES IN EMERGENCY SPILLWAYS SHALL BE CHECKED BASED ON THE VELOCITY OF THE PEAK FLOW IN THE SPILLWAY RESULTING FROM ROUTING THE SPILLWAY DESIGN STORM HYDROGRAPH AS DEFINED IN THE NJ DEP DAM SAFETY RULES (N.J.A.C. 7:20) FOR ALL DETENTION FACILITIES CLASSIFIED AS DAMS AND THE 100-YEAR STORM HYDROGRAPH FOR ALL OTHER FACILITIES (THE ROUTED EMERGENCY SPILLWAY HYDROGRAPH). THE DESIGN OF THE EMERGENCY SPILLWAY WILL BE BASED ON THE 100-YEAR INFLOW TO THE BASIN EXCEPT FOR CLASS IV DAMS, WHICH SHALL COMPLY WITH THE DAM SAFETY STANDARDS N.J.A.C. 7:20.

DETENTION FACILITY CROSS SECTION


Not to Scale



TOWNSHIP OF BRANCHBURG

1077 Route 202 North Branchburg, New Jersey 08876-3936 TELE: (908)526-1300 FAX: (908)526-2452 STANDARD CONSTRUCTION DETAILS
STORM SEWERS
OUTLET STRUCTURE/DETENTION FACILITY

DOUGLAS A. BALL,	P.E., TOWNSHIP ENGINEE	R		
DATE: 2-1-10	SCALE : NTS	DRAWN BY: JAR	REVISED 1-18-13	42C

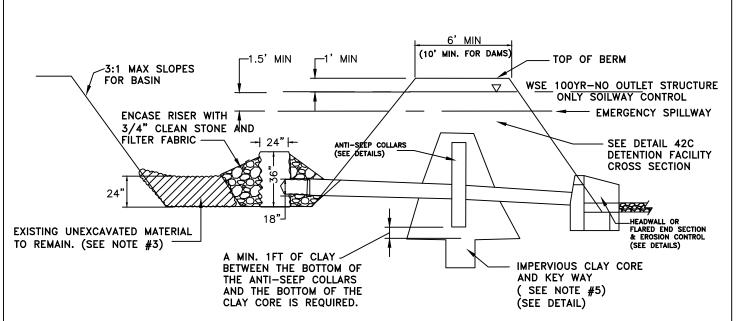

- A TEMPORARY SEDIMENT BASIN SHALL BE CONSTRUCTED AS PART OF THE OVERALL SOIL EROSION SEDIMENT CONTROL PLAN.
- SEQUENCE OF CONSTRUCTION AS FOLLOWS;
 - INSTALLATION OF TRACKING PAD AND SILT FENCE AT THE LIMIT OF DISTURBANCE.
 - CLEARING OF SITE.
 - STRIPPING & STOCKPILING TOPSOIL.
 - CONSTRUCT TEMPORARY SEDIMENT BASIN.
- 3. CONTRACTOR SHALL NOT EXCAVATE THE BOTTOM 24" OF THE FINAL BASIN DURING USE AS A TEMPORARY SEDIMENT BASINS. IF CONTRACTOR OVER EXCAVATES THE TSB, THE FINAL BASIN SHALL BE OVER EXCAVATED BY THE SAME AMOUNT AND THE AREAS ARE TO BE FILLED WITH SAND MATERIAL WHEN BASIN IS CONVERTED TO FINAL INFILTRATION / DETENTION BASIN AT THE COMPLETION OF CONSTRUCTION SEQUENCE.
- 4. CONTRACTOR SHALL EXCAVATE TO FINAL BASIN GRADE ONLY AROUND THE OUTLET STRUCTURE AS NECESSARY TO INSTALL THE TEMPORARY SEDIMENT RISER.
- 5. CONTRACTOR SHALL INSTALL THE CLAY CORE TO 20 FEET ON BOTH SIDES OF THE PERMANENT OUTLET PIPES AND ANTI SEEP COLLARS. THE REMAINDER OF THE CLAY CORE ZONES SHALL BE INSTALLED WHEN THE BASINS ARE CONVERTED TO FINAL INFILTRATION / DETENTION BASINS AT THE COMPLETION OF CONSTRUCTION SEQUENCE. SEE DETAILS FOR IMPERVIOUS CLAY CORE.
- 6. THE CLAY CORE SHALL BE COMPOSED OF MATERIAL THAT HAS A PERMEABILITY RATE OF 10 ^ 7 CM/S OR LESS.
- 7. PRIOR TO THE INSTALLATION OF THE CLAY CORE, THE CONTRACTOR SHALL PROVIDE THE NECESSARY TEST RESULTS OF THE INTENDED CLAY MATERIALS. SAMPLES SHALL BE TAKEN BY A QUALIFIED GEOTECHNICAL ENGINEER AND WITNESSED BY A TOWNSHIP OFFICIAL.
- 8. THE INSTALLATION OF THE CLAY CORE SHALL BE OBSERVED AND COMPACTION TESTED BY A QUALIFIED GEOTECHNICAL ENGINEER, SUPPLIED BY THE OWNER.


TEMPORARY SEDIMENT BASIN CROSS SECTION

Not to Scale



TOWNSHIP OF BRANCHBURG

1077 Route 202 North Branchburg, New Jersey 08876-3936 TELE: (908)526-1300 FAX: (908)526-2452 STANDARD CONSTRUCTION DETAILS STORM SEWERS TEMPORARY SEDIMENT BASIN

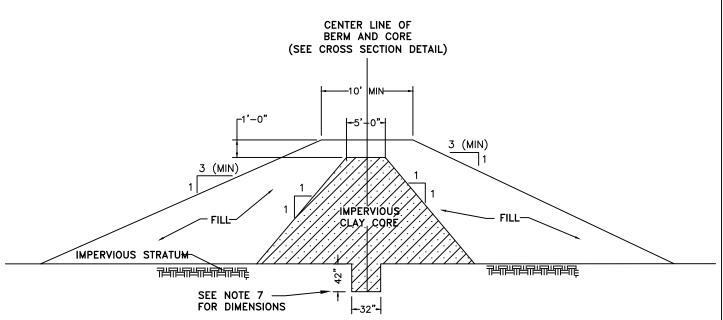

- 1. SITE PLANS SHALL PROVIDE THE LIMITS OF THE CLAY CORE: FOR EMBANKMENT OR BERM THE LIMITS SHALL BE FOR THE FULL LENGTH OF THE BERM. FOR A RECESSED THE LIMITS SHALL BE 40 FEET O.C. OF THE OUTLET PIPE. CUT SHEETS SHALL BE SUBMITTED TO THE ENGINEERING DEPARTMENT FOR REVIEW. AT THE TIME OF CONSTRUCTION THE BERM SHALL BE CONSTRUCTED 5% HIGHER TO ALLOW FOR SETTLEMENT.
- 2. THE IMPERVIOUS CORE SHALL BE CONSTRUCTED OF SOIL MATERIAL CLASSIFIED AS "CL" IN THE UNIFIED SOIL CLASSIFICATION SYSTEM, SAID MATERIAL SHALL BE PLACED AND COMPACTED IN ACCORDANCE WITH SECTION 2.03 EMBANKMENT, NJDOT SPECIFICATIONS FOR ROAD AND BRIDGE CONSTRUCTION. COMPACTION SHALL MEET A MINIMUM 95% DENSITY AS MEASURED BY THE STANDARD PROCTOR DENSITY TEST (ASTM TEST DESIGNATION D-1557 AND ASSHTO TEST DESIGNATION T-180).
- 3. THE CLAY CORE SHALL BE COMPOSED OF MATERIAL THAT HAS PERMEABILITY RATE OF 10 ▼7 CM/S OR LESS.
- 4. THE USE OF ONSITE MATERIAL;
- A) SAMPLES OBTAINED MUST BE WITNESSED BY A REPRESENTATIVE FROM THE ENGINEERING DEPARTMENT.
- B) ONCE APPROVED THE MATERIAL NEEDED MUST BE QUANTIFIED, THEN SEPARATELY STOCKPILED & QUANTIFIED AND RETESTED FOR CONTINUITY SAMPLES TAKEN MUST BE WITNESSED BY A REPRESENTATIVE FROM THE ENGINEERING DEPARTMENT.
- PRIOR TO INSTALLATION THE CONTRACTOR SHALL PROVIDE THE TOWNSHIP THE NECESSARY TEST RESULTS AND LOCATION OF THE INTENDED CLAY MATERIAL.
- 6. THE INSTALLATION OF THE CLAY CORE SHALL BE OBSERVED & TESTED BY A QUALIFIED GEO-TECH ENGINEER, SUPPLIED BY THE OWNER AND WITNESSED BY A REPRESENTATIVE FROM THE ENGINEERING DEPARTMENT.
- 7. KEY WAY DETAIL; DEPTH OF KEY WAY SHALL BE 42" BELOW THE BOTTOM OF THE CLAY CORE OR A MINIMUM OF 12" INTO THE IMPERVIOUS STRATUM. THE IMPERVIOUS STRATUM SHALL BE DETERMINED BY THE TOWNSHIP ENGINEER/REPRESENTATIVE AND THE GEO-TECH ENGINEER, SUPPLIED BY THE OWNER.
- 8. A MEMBRANE CAN BE USED AS AN ACCEPTABLE SUBSTITUTION FOR A CLAY CORE. MEMBRANE SHALL BE 60MIL. MINIMUM WITH BOTH SIDES OF THE MEMBRANE PROTECTED WITH A PROTECTIVE FABRIC MIRAFI 180 OR APPROVED EQUAL. DESIGN AND LIMITS SHALL SUBMITTED TO THE ENGINEERS OFFICE FOR REVIEW AND APPROVAL.


IMPERVIOUS CLAY CORE

Not to Scale



TOWNSHIP OF BRANCHBURG

1077 Route 202 North Branchburg, New Jersey 08876-3936 TELE: (908)526-1300 FAX: (908)526-2452 STANDARD CONSTRUCTION DETAILS
STORM SEWERS
OUTLET STRUCTURE/DETENTION FACILITY

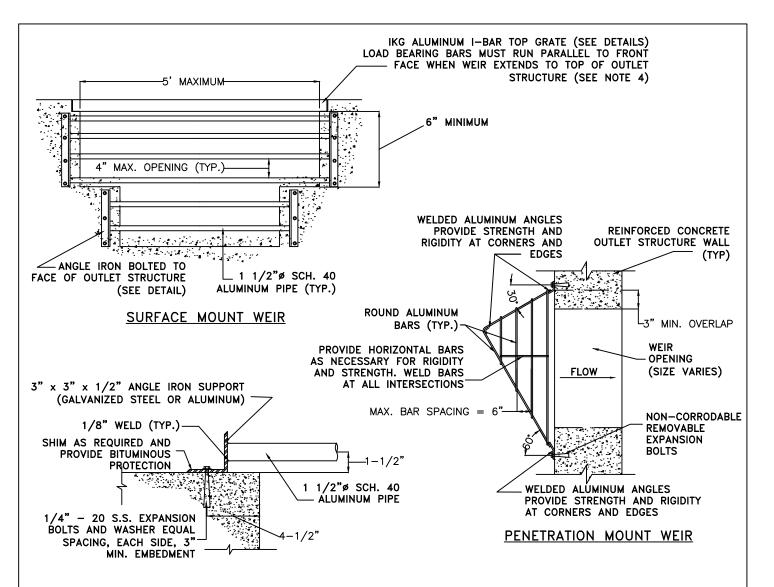

- ALL PIPES, STRUCTURES AND DESIGN SHALL ADHERE TO THE "RESIDENTAIL SITE IMPROVEMENT STANDARD", SUBCHAPTER 7 STORMWATER MANAGEMENT. SHOP DRAWINGS SHALL BE SUBMITTED TO THE ENGINEERING DEPARTMENT FOR REVIEW AND APPROVAL.
- 2. VELOCITIES IN OPEN CHANNELS, EXCLUDING WATER QUALITY SWALE, AT DESIGN FLOW SHALL NOT BE LESS THAN 0.5 FOOT PER SECOND AND NOT GREATER THAN A VELOCITY THAT WILL CAUSE EROSION OR SCOURING OF THE CHANNEL. DESIGN ENGINNERS SHALL DETERMINE PERMISSIBLE VELOCITIES FOR SWALES, OPEN CHANNELS AND DITCHES USING METHODS PRESENTED IN "STANDARDS FOR SOIL EROSION AND SEDIMENT CONTROL IN NEW JERSEY" AT N.J.A.C. 2:90.
- 3. THE AVERAGE VELOCITY FLOW THROUGH A CLEAN TRASH RACK IS NOT TO EXCEED 2.5 FEET PER SECOND UNDER THE FULL RANGE OF STAGE AND DISCHARGE. VELOCITY IS TO BE COMPUTED ON THE BASIS OF THE NET AREA OF THE OPENING THROUGH THE RACK.
- 4. TRASH RACKS AND OVERFLOW GRATES SHALL BE CONSTRUCTED AND INSTALLED TO BE RIGID, DURABLE AND CORROSION RESISTANT, AND SHALL BE DESIGNED TO WITHSTAND A PERPENDICULAR LIVE LOADING OF 300 POUNDS PER SQUARE FOOT.

WEIR TRASH RACK

Not to Scale



TOWNSHIP OF BRANCHBURG

1077 Route 202 North Branchburg, New Jersey 08876-3936 TELE: (908)526-1300 FAX: (908)526-2452 STANDARD CONSTRUCTION DETAILS
STORM SEWERS
OUTLET STRUCTURE/DETENTION FACILITY

DOUGLAS A. BALL,	P.E., TOWNSHIP ENGINEER	R		
DATE: 2-1-10	SCALE : NTS	DRAWN BY: JAR	REVISED 8-16-11	42E

THIS DETAIL SHALL COMPLY FOR BOTH TOP AND WING WALL GRATES OF THE STRUCTURE.

SADDLE CLIP SUPPLIED BY MFR. - 24" O.C. MAX.

CONTINUOUS GALVANIZED STEEL ANGLE FORMS TRASH RACK SEAT. MUST BE THE ENTIRE LENGTH OF THE WINGWALL. ENTIRE TRASH RACK FRAME TO BE HOT-DIPPED GALVANIZED AFTER WFI DING.

> PROVIDE CONCRETE LEDGE TO ALLOW GRATE TO REST ON ACHORED ANGLE IRON SEAT (SEE DETAIL 'A')

THIS DETAIL SHALL BE CONSTRUCTED FOR THE GRATES ON TOP AND WING WALL SECTION OF THE STRUCTURE.

1/4" - 20 S.S. MACH. BOLT AND WASHER 24" O.C.

NOTES:

ANGLE IRON CONTINUOUS SEAT 3 1/2"

X 2 1/2" X 1/4" (GALVANIZED STEEL
OR ALUMINUM)

SADDLE CLIP SUPPLIED BY MFR. - 24" O.C. MAX.

-1/4" CLEAR,

IKG GALOK ALUMINUM
I BAR GRATE TYPE
S194-I WITH 2 1/4"
DEEP BEARING BARS
ON 1 3/16" CENTERS
WITH CROSS BARS ON
4" CENTERS OR AN
APPROVED EQUAL

1 1/2" X 1 1/2" X -1/2" BACKING WELDED TO ANGLE, DRILL AND TAP FOR 1/4" - 20 BOLT, 24" O.C. MAX.

ANCHORS - 1/4" X 2"X 6"⊕ 24" O.C. MAX. (MIN. 3 PER SIDE) WELDED TO ANGLE

. ALL PIPES, STRUCTURES AND DESIGN SHALL ADHERE TO THE "RESIDENTIAL SITE IMPROVEMENT STANDARD", SUBCHAPTER 7 STORMWATER MANAGEMENT. SHOP DRAWINGS SHALL BE SUBMITTED TO THE ENGINEERING DEPARTMENT FOR REVIEW AND APPROVAL.

- VELOCITIES IN OPEN CHANNELS, EXCLUDING WATER QUALITY SWALE, AT DESIGN FLOW SHALL NOT BE LESS THAN 0.5 FOOT PER SECOND AND NOT GREATER THAN A VELOCITY THAT WILL CAUSE EROSION OR SCOURING OF THE CHANNEL. DESIGN ENGINNERS SHALL DETERMINE PERMISSIBLE VELOCITIES FOR SWALES, OPEN CHANNELS AND DITCHES USING METHODS PRESENTED IN "STANDARDS FOR SOIL EROSION AND SEDIMENT CONTROL IN NEW JERSEY" AT N.J.A.C. 2:90.
- 3. THE AVERAGE VELOCITY FLOW THROUGH A CLEAN TRASH RACKIS NOT TO EXCEED 2.5 FEET PER SECOND UNDER THE FULL RANGE OF STAGE AND DISCHARGE. VELOCITY IS TO BE COMPUTED ON THE BASIS OF THE NET AREA OF THE OPENING THROUGH THE RACK.
- 4. TRASH RACKS AND OVERFLOW GRATES SHALL BE CONSTRUCTED AND INSTALLED TO BE RIGID, DURABLE AND CORROSION RESISTANT, AND SHALL BE DESIGNED TO WITHSTAND A PERPENDICULAR LIVE LOADING OF 300 POUNDS PER SQUARE FOOT.
- 5. ALL TRASH RACKS MUST HAVE SUFFICIENT NET OPEN AREA PERPENDICULAR TO FLOW TO CONVEY PEAK DESIGN FLOW THROUGH THEM WITH MAXIMUM VELOCITY OF 2 FPS IN MOST CASES. PEAK DESIGN FLOW SHOULD BE BASED UPON PASSAGE OF EMERGENCY SPILLWAY HYDROGRAPH.
- 6. ALL TRASH RACKS AND FASTENERS MUST HAVE SUFFICIENT STRENGTH TO WITHSTAND ANTICIPATED H-20 LOADS.

TRASH RACK TOP & WING WALL

Not to Scale

OF BRANCE OF BRANCE OF STATE O

TOWNSHIP OF BRANCHBURG

1077 Route 202 North Branchburg, New Jersey 08876-3936 TELE: (908)526-1300 FAX: (908)526-2452 STANDARD CONSTRUCTION DETAILS
STORM SEWERS
OUTLET STRUCTURE/DETENTION FACILITY

DOUGLAS A. BALL, P.E., TOWNSHIP ENGINEER

DATE: 2-1-10 | SCALE : NTS | DRAWN BY: JAR | REV. 2015 | 42F

ALL I-BAR ENDS MUST MAKE CONTACT AND REST ON FACE OF OUTLET STRUCTURE. ADDITIONAL SUPPORT MAY BE REQUIRED

IKG GALOK ALUMINUM I BAR GRATE TYPE S194-I WITH 2 1/4" DEEP BEARING BARS ON 1 3/16" CENTERS WITH CROSS BARS ON 4" CENTERS OR AN APPROVED EQUAL


> CONTINUOUS GALVANIZED STEEL ANGLE FORMS TRASH RACK SEAT. - MUST BE THE ENTIRE LENGTH OF THE WINGWALL. ENTIRE TRASH RACK FRAME TO BE HOT—DIPPED GALVANIZED AFTER WELDING.

> > PROVIDE CONCRETE LEDGE TO ALLOW GRATE TO REST ON ACHORED ANGLE IRON SEAT

IKG GALOK ALUMINUM I BAR GRATE TYPE S194-I WITH 2 1/4" DEEP BEARING BARS ON 1 3/16" CENTERS WITH CROSS BARS ON 4" CENTERS OR AN APPROVED EOUAL

ALL I-BAR ENDS MUST
MAKE CONTACT AND REST
ON BOTTOM OF OUTLET
STRUCTURE

EXPANSION JOINT TO BE PROVIDED AT CONNECTION BETWEEN OUTLET STRUCTURE AND LOW-FLOW CHANNEL

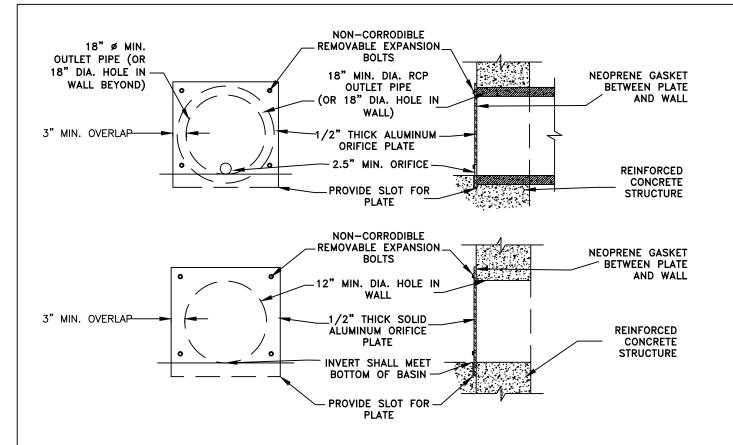

- 1. ALL PIPES, STRUCTURES AND DESIGN SHALL ADHERE TO THE "RESIDENTIAL SITE IMPROVEMENT STANDARD", SUBCHAPTER 7 STORMWATER MANAGEMENT. SHOP DRAWINGS SHALL BE SUBMITTED TO THE ENGINEERING DEPARTMENT FOR REVIEW AND APPROVAL.
- VELOCITIES IN OPEN CHANNELS, EXCLUDING WATER QUALITY SWALE, AT DESIGN FLOW SHALL NOT BE LESS THAN 0.5 FOOT PER SECOND AND NOT GREATER THAN A VELOCITY THAT WILL CAUSE EROSION OR SCOURING OF THE CHANNEL. DESIGN ENGINNERS SHALL DETERMINE PERMISSIBLE VELOCITIES FOR SWALES, OPEN CHANNELS AND DITCHES USING METHODS PRESENTED IN "STANDARDS FOR SOIL EROSION AND SEDIMENT CONTROL IN NEW JERSEY" AT N.J.A.C. 2:90.
- 3. THE AVERAGE VELOCITY FLOW THROUGH A CLEAN TRASH RACKIS NOT TO EXCEED 2.5 FEET PER SECOND UNDER THE FULL RANGE OF STAGE AND DISCHARGE. VELOCITY IS TO BE COMPUTED ON THE BASIS OF THE NET AREA OF THE OPENING THROUGH THE RACK.
- 4. TRASH RACKS AND OVERFLOW GRATES SHALL BE CONSTRUCTED AND INSTALLED TO BE RIGID, DURABLE AND CORROSION RESISTANT, AND SHALL BE DESIGNED TO WITHSTAND A PERPENDICULAR LIVE LOADING OF 300 POUNDS PER SQUARE FOOT.

ORIFICE PLATE DETAIL


Not to Scale



TOWNSHIP OF BRANCHBURG

1077 Route 202 North Branchburg, New Jersey 08876-3936 TELE: (908)526-1300 FAX: (908)526-2452 STANDARD CONSTRUCTION DETAILS
STORM SEWERS
OUTLET STRUCTURE/DETENTION FACILITY

DOUGLAS A. BALL,	P.E., TOWNSHIP ENGINEE	R		
DATE: 2-1-10	SCALE : NTS	DRAWN BY: JAR	REVISED 8-16-11	42G

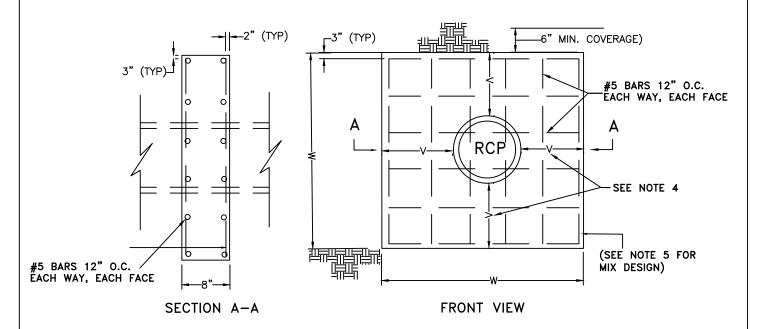

- 1. IN GENERAL, NO PIPE SIZE IN THE STORM DRAINAGE SYSTEM SHALL BE LESS THAN 15" IN DIAMETER. DESIGN ENGINEERS MAY USE A 12" DIAMETER PIPE AS A CROSS-DRAIN TO A SINGLE INLET.
- 2. EIGHT INCH THICK ANTI-SEEP COLLARS ARE TO BE INSTALLED ALONG OUTLET PIPES WHEN REQUIRED BY THE MUNICIPAL ENGINEER. REINFORCEMENT STEEL SHALL BE NO. 5 BARS AT 12 INCHES BOTH WAYS, WITH TOW INCHES OF COVER ON BOTH.
- 3. DESIGN ENGINEERS SHALL USE THE FOLLOWING CRITERIA TO DETERMINE THE SIZE AND NUMBER OF ANTI-SEEP COLLARS. THE RATIO (L+2nV)/L SHALL BE AT LEAST 1.15. ANTI-SEEP COLLARS SHOULD BE EQUALLY SPACED ALONG PART OF THE BARREL WITHIN THE SATURATED ZONE AT DISTANCES NOT MORE THAN 25 FEET.
- 4. THE MIX, DESIGN AND TESTING OF CONCRETE SHALL BE CONSISTENT WITH THE SIZE REQUIREMENTS OF THE JOB. MIX REQUIREMENTS OR NECESSARY STRENGTH SHALL BE SPECIFIED.
- 5. PRIOR TO THE CONSTRUCTION OF THE ANTI-SEEP COLLARS, THE OUTSIDE OF THE PIPE SHOULD BE CLEANED AND A BONDING AGENT BE APPLIED TO THE COLLAR AREA. PRE-CAST ANTI-SEEP COLLARS SHALL NOT HAVE MORE THAN 2 INCHES OF SPACE BETWEEN COLLAR AND PIPE. THE SPACE SHALL BE SEALED WITH A DURABLE, STRONG AND WATER RESISTANT MATERIAL. APPROVED BY THE TOWNSHIP ENGINEER.

ANTI-SEEP COLLARS


Not to Scale



TOWNSHIP OF BRANCHBURG

1077 Route 202 North Branchburg, New Jersey 08876-3936 TELE: (908)526-1300 FAX: (908)526-2452 STANDARD CONSTRUCTION DETAILS
STORM SEWERS
OUTLET STRUCTURE/DETENTION FACILITY

DOUGLAS A. BALL,	P.E., TOWNSHIP ENGINEE	R		
DATE: 2-1-10	SCALE : NTS	DRAWN BY: JAR	REV: 2018	42H

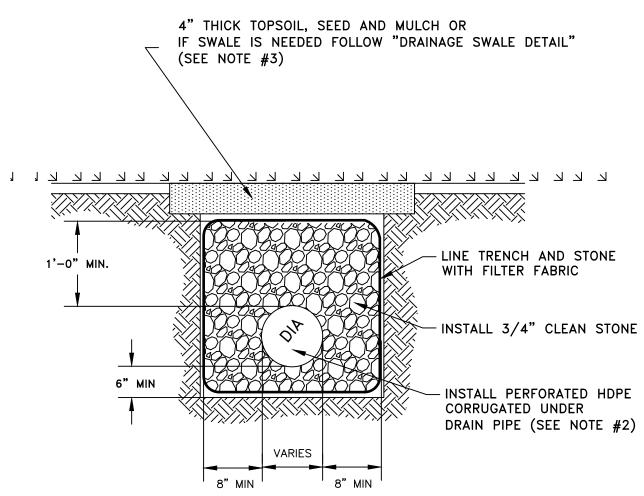

- 1. AN APPLICATION TO OPEN PUBLIC GROUNDS IS REQUIRED BY THE BRANCHBURG TOWNSHIP ENGINEERING DEPARTMENT.
- 2. ALL PIPE MUST BE RATED A MINIMUM OF H-20 LOAD AND FOLLOW MANUFACTURES MINIMUM DEPTH / COVERAGE REQUIREMENTS.
- 3. ALL EXCAVATIONS INTO THE PAVED AREAS MUST FOLLOW THE TOWNSHIP REQUIREMENT TO BACKFILL THE TRENCH WITH DENSE GRADED AGGREGATE OR APPROVED EQUIVALENT.

UNDER DRAIN PIPE DETAIL Not to Scale




TOWNSHIP OF BRANCHBURG

1077 Route 202 North Branchburg, New Jersey 08876-3936 TELE: (908)526-1300 FAX: (908)526-2452 STANDARD CONSTRUCTION DETAILS MISCELLANEOUS—STORM UNDER DRAIN PIPE DETAIL

DOUGLAS A. BALL, P.E., TOWNSHIP ENGINEER


DATE: 2-2-10 SCALE: NTS DRAWN BY: JAR REV: 8/2014 43

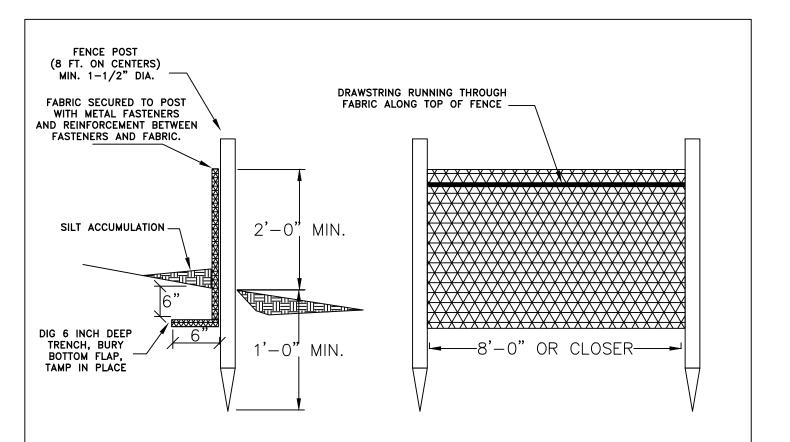

REQUIREMENTS FOR SILT FENCE

- 1. FENCE POST SHALL BE SPACED 8 FEET CENTER TO CENTER OR CLOSER. THEY SHALL EXTEND AT LEAST 1 FOOT INTO THE GROUND AND EXTEND AT LEAST 2 FEET ABOVE GROUND. POST SHALL BE CONSTRUCTED OF HARDWOOD WITH A MINIMUM DIAMETER THICKNESS OF 1-1/2 INCHES.
- 2. A METAL FENCE WITH 6 INCH OR SMALLER OPENINGS AND AT LEAST 2 FEET HIGH MAY BE UTILIZED, FASTENED TO THE FENCE POST, TO PROVIDE REINFORCEMENT AND SUPPORT TO THE GEO-TEXTILE FABRIC WHERE SPACE FOR OTHER PRACTICES IS LIMITED AND HEAVY SEDIMENT LOADING IS EXPECTED.
- 3. A GEO-TEXTILE FABRIC IS RECOMMENDED FOR SUCH USE BY THE MANUFACTURER, BURIED AT LEAST 6 INCHES DEEP IN THE GROUND. THE FABRIC SHALL EXTEND AT LEAST 2 FEET ABOVE THE GROUND. THE FABRIC MUST BE SECURELY FASTENED TO THE POST USING A SYSTEM CONSISTING OF METAL FASTENERS (NAILS OR STAPLES) AND A HIGH STRENGTH REINFORCEMENT MATERIAL (NYLON WEBBING, GROMMETS, WASHERS, ETC.) PLACED BETWEEN THE FASTENERS AND THE GEOTEXTILE FABRIC. THE FASTENING SYSTEM SHALL RESIST TEARING AWAY FROM THE POST. THE FABRIC SHALL INCORPORATE A DRAW STRING IN THE TOP PORTION OF THE FENCE FOR ADDED STRENGTH.
- 4. MAY REQUIRE THE FOLLOWING:
 NOTIFICATION AND APPROVAL FROM SOMERSET-UNION CONSERVATION DISTRICT.
 REQUIREMENTS OF IMPORTING AND/OR EXPORTING MATERIAL BY THE ENGINEERING DEPARTMENT.

SILT FENCE DETAIL

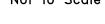




TOWNSHIP OF BRANCHBURG

1077 Route 202 North Branchburg, New Jersey 08876-3936 TELE: (908)526-1300 FAX: (908)526-2452 STANDARD CONSTRUCTION DETAILS
MISCELLANEOUS—SOIL EROSION CONTROL
SILT FENCE DETAIL

DOUGLAS A. BALL,	P.E., TOWNSHIP ENGINEER	R		
DATE: 2-1-10	SCALE : NTS	DRAWN BY: JAR	REV: 2015	44

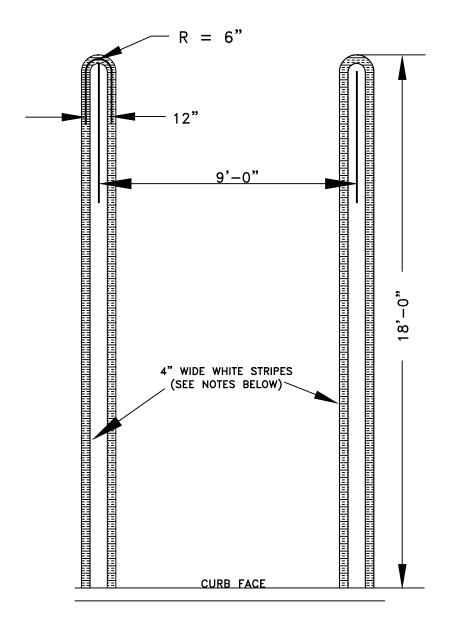

NOTE

- 1. ALL TRAFFIC MARKINGS, SIGNS AND POSITION MUST BE IN ACCORDANCE WITH THE MOST RECENT EDITION OF THE FEDERAL HIGHWAY ADMINISTRATION, MANUAL ON UNIFORM TRAFFIC CONTROL DEVICES.
- 2. HANDICAP ACCESSIBILITY SHOULD CONFORM WITH THE FOLLOWING: AMERICANS WITH DISABILITIES ACT THE BARRIER FREE SUBCODE OF THE NJ UNIFORM CONSTRUCTION CODE (NJAC 5:23-7) PROWAG ADAAG AND SHALL BE APPLICABLE FOR ALL SITE IMPROVEMENTS, RIGHT OF WAYS, STREET INTERSECTIONS AND WHERE DEEMED NECESSARY BY THE TOWNSHIP ENGINEER.
- 3. ZONING COMPLIANCE OR APPROVALS MAY BE REQUIRED.

HAIRPIN PARKING STRIPING

Not to Scale




TOWNSHIP OF BRANCHBURG

1077 Route 202 North Branchburg, New Jersey 08876-3936 TELE: (908)526-1300 FAX: (908)526-2452 STANDARD CONSTRUCTION DETAILS
MISCELLANEOUS-ROAD
HAIRPIN PARKING STRIPING

P ENGINEER

DATE: 2-1-10 SCALE: NTS DRAWN BY: JAR REV: 2015 45

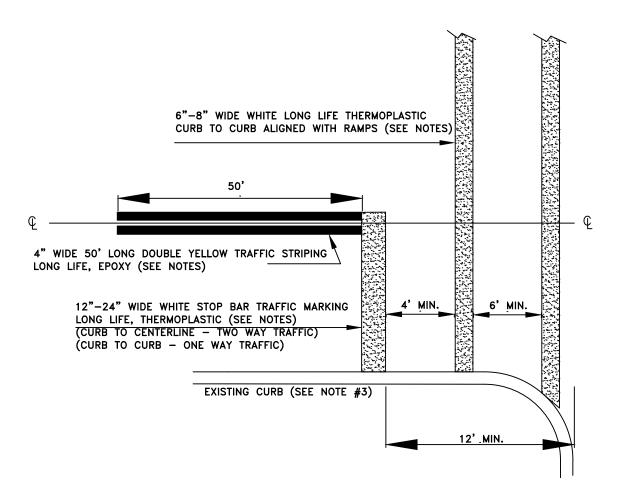

- 1. ALL TRAFFIC MARKINGS, SIGNS AND POSITION MUST BE IN ACCORDANCE WITH THE MOST RECENT EDITION OF THE FEDERAL HIGHWAY ADMINISTRATION, MANUAL ON UNIFORM TRAFFIC CONTROL DEVICES.
- 2. ALL TRAFFIC STRIPING AND TRAFFIC MARKINGS SHALL BE RETRO REFLECTIVE, LONG LIFE FOR BOTH EPOXY AND THERMOPLASTIC.
- 3. HANDICAP ACCESSIBILITY SHOULD CONFORM WITH THE FOLLOWING: AMERICANS WITH DISABILITIES ACT THE BARRIER FREE SUBCODE OF THE NJ UNIFORM CONSTRUCTION CODE (NJAC 5:23-7) PROWAG ADAAG AND SHALL BE APPLICABLE FOR ALL SITE IMPROVEMENTS, RIGHT OF WAYS, STREET INTERSECTIONS AND WHERE DEEMED NECESSARY BY THE TOWNSHIP ENGINEER.
- 4. AN APPLICATION TO OPEN PUBLIC GROUNDS MAY BE REQUIRED BY BRANCHBURG TOWNSHIP.

TRAFFIC STRIPING & TRAFFIC MARKINGS CROSSWALKS, STOP BAR & CENTERLINES Not to Scale





TOWNSHIP OF BRANCHBURG

1077 Route 202 North Branchburg, New Jersey 08876-3936 TELE: (908)526-1300 FAX: (908)526-2452 STANDARD CONSTRUCTION DETAILS
MISCELLANEOUS-ROAD
TRAFFIC STRIPING & MARKINGS

DOUGLAS A. BALL, P.E., TOWNSHIP ENGINEER

DATE: 2-1-10 SCALE : NTS DRAWN BY: JAR REV: 2015 46

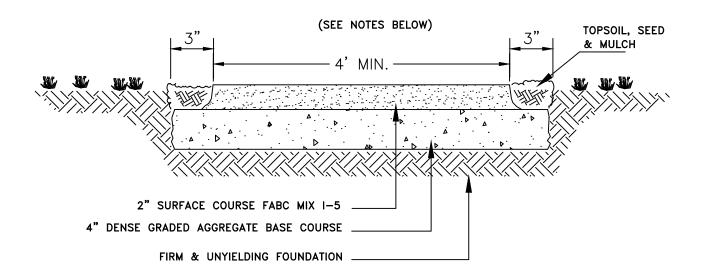

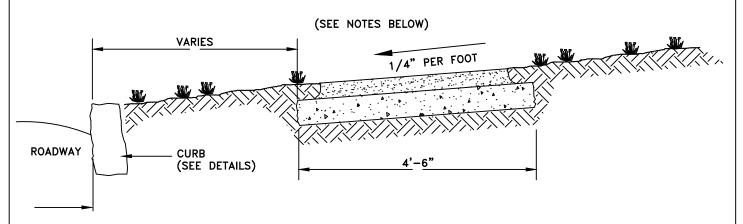

NOTE

- 1. AN APPLICATION TO OPEN PUBLIC GROUNDS IS REQUIRED BY THE BRANCHBURG TOWNSHIP ENGINEERING DEPARTMENT WHEN WORKING WITHIN THE TOWNSHIP RIGHT OF WAY.
- 2. HANDICAP ACCESSIBILITY SHOULD CONFORM WITH THE FOLLOWING: AMERICANS DISABILITIES ACT THE BARRIER FREE SUBCODE OF THE NJ UNIFORM CONSTRUCTION CODE (NJAC 5:23-7) ADAAG SHALL BE APPLICABLE FOR ALL SITE IMPROVEMENTS. PROWAG SHALL BE APPLICABLE TO ANY PUBLIC RIGHT OF WAYS (TITLE 39 ENFORCED ROADWAYS), STREET INTERSECTIONS AND WHERE DEEMED NECESSARY BY THE TOWNSHIP ENGINEER.
- 3. ANY HANDICAP RAMPS AND ADJOINING SIDEWALKS SHALL BE CONSTRUCTED IN CONCRETE WITH APPROVED DETECTABLE WARNING SURFACE TILES (SEE DETAIL). A PLAN WITH GRADING AND ELEVATIONS MAY BE REQUIRED FOR REVIEW BY THE ENGINEERING DEPARTMENT FOR THIS APPLICATION.
- 4. ALL HANDICAP RAMPS MUST BE DESIGNED BY A LICENSED ENGINEER OR NJPLS AND SUBMITTED TO THE TO TOWNSHIP ENGINEER FOR REVIEW.


BITUMINOUS CONCRETE SIDEWALK

Not to Scale



TOWNSHIP OF BRANCHBURG

1077 Route 202 North Branchburg, New Jersey 08876-3936 TELE: (908)526-1300 FAX: (908)526-2452 STANDARD CONSTRUCTION DETAILS MISCELLANEOUS-ROAD BITUMINOUS CONCRETE SIDEWALKS

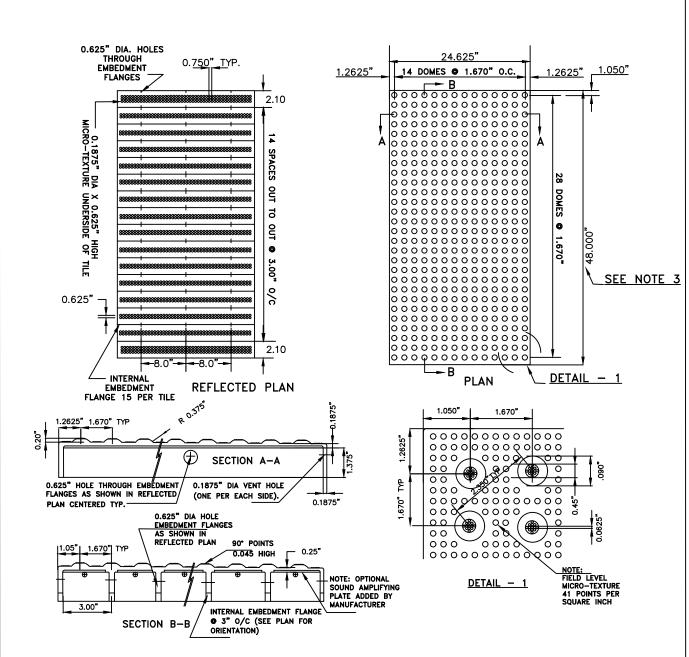

- 1. LANDICAP ACCESSIBILITY SHOULD CONFORM WITH THE FOLLOWING: AMERICANS DISABILITIES ACT THE BARRIER FREE SUBCODE OF THE NJ UNIFORM CONSTRUCTION CODE (NJAC 5:23-7) ADAAG SHALL BE APPLICABLE FOR ALL SITE IMPROVEMENTS. PROWAG SHALL BE APPLICABLE TO ANY PUBLIC RIGHT OF WAYS, STREET INTERSECTIONS AND WHERE DEEMED NECESSARY BY THE TOWNSHIP ENGINEER.
- 2. ANY HANDICAP RAMPS AND ADJOINING SIDEWALKS SHALL BE CONSTRUCTED IN CONCRETE WITH APPROVED DETECTABLE WARNING SURFACE TILES (SEE DETAIL). A PLAN WITH GRADING AND ELEVATIONS MAY BE REQUIRED FOR REVIEW BY THE ENGINEERING DEPARTMENT FOR THIS APPLICATION.
- 3. DETECTABLE WARNING SURFACE TILES SHALL BE INSTALLED ALONG THE ENTIRE WIDTH OF THE CURB RAMP.

DETECTABLE/WARNING SURFACE TILE Not to Scale




TOWNSHIP OF BRANCHBURG

1077 Route 202 North Branchburg, New Jersey 08876-3936 TELE: (908)526-1300 FAX: (908)526-2452 STANDARD CONSTRUCTION DETAILS
MISCELLANEOUS-ROAD
DETECTABLE/WARNING SURFACE TILE

DOUGLAS A. BALL, P.E., TOWNSHIP ENGINEER

DATE: 2-1-10 | SCALE : NTS | DRAWN BY: JAR | REV: 2018 48

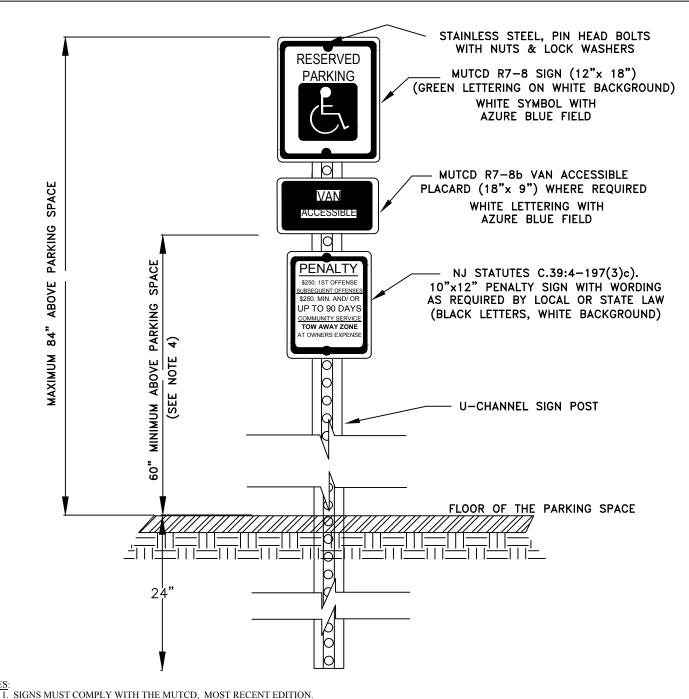

- 2. MUST COMPLY WITH ALL REQUIREMENTS OF THE ICC/ANSI A117, MOST RECENT EDITION.
- 3. CODE ENFORCEMENT AND/OR ZONING PERMITS MAY BE REQUIRED.
- 4. IF THE "VAN ACCESSIBLE" PLACARD IS NOT USED, THEN THE "RESERVE PARKING" SIGN SHALL BE PLACED AT 60" MINIMUM ABOVE THE PARKING SPACE.

HANDICAP PARKING SIGN


Not to Scale




TOWNSHIP OF BRANCHBURG

1077 Route 202 North Branchburg, New Jersey 08876-3936 TELE: (908)526-1300 FAX: (908)526-2452 STANDARD CONSTRUCTION DETAILS HANDICAP PARKING SIGN DETAIL

DOUGLAS A. BALL,	P.E., TOWNSHIP ENGINEE	R		
DATE: 1-3-12	SCALE : NTS	DRAWN BY: JAR	REV: 2018	49

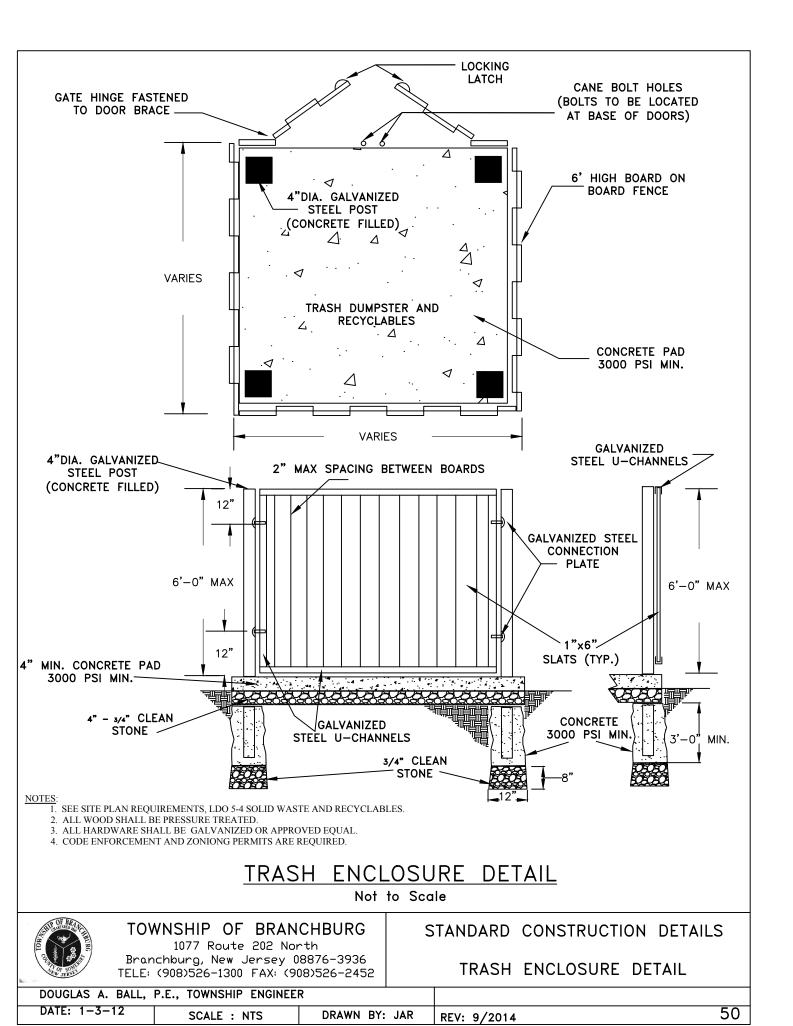

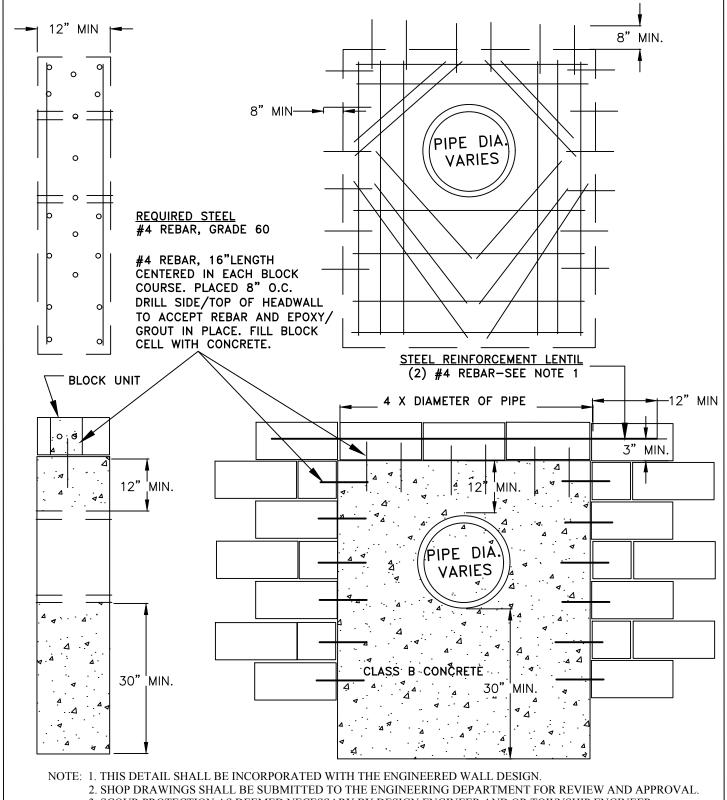

- 3. SCOUR PROTECTION AS DEEMED NECESSARY BY DESIGN ENGINEER AND OR TOWNSHIP ENGINEER.
- 4. CODE ENFORCEMENT AND/OR ZONING MAY BE REQUIRED.

DOWELED CONCRETE HEADWALL

Not to Scale



TOWNSHIP OF BRANCHBURG

1077 Route 202 North Branchburg, New Jersey 08876-3936 TELE: (908)526-1300 FAX: (908)526-2452 STANDARD CONSTRUCTION DETAILS
MISCELLANEOUS — STORM SEWER
DOWELED CONCRETE HEADWALL

DOUGLAS A. BALL, P.E., TOWNSHIP ENGINEER				
DATE: 9-23-2015	SCALE : NTS	DRAWN BY: JAR	REV: 2018	51