


PROPOSED SITE PLAN DOCUMENTS



FOR EXISTING

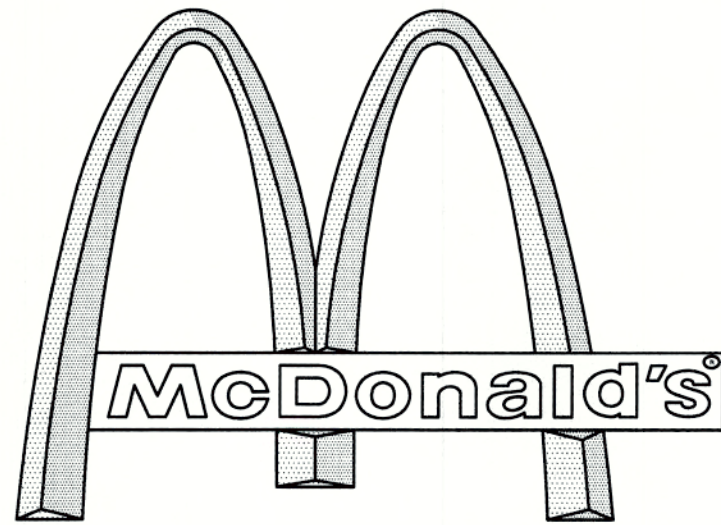

WITH DRIVE-THRU

LOCATION OF SITE

117-119 WEST STREET, TOWN OF WARE
HAMPSHIRE COUNTY, MASSACHUSETTS
MAP 56, LOT 111

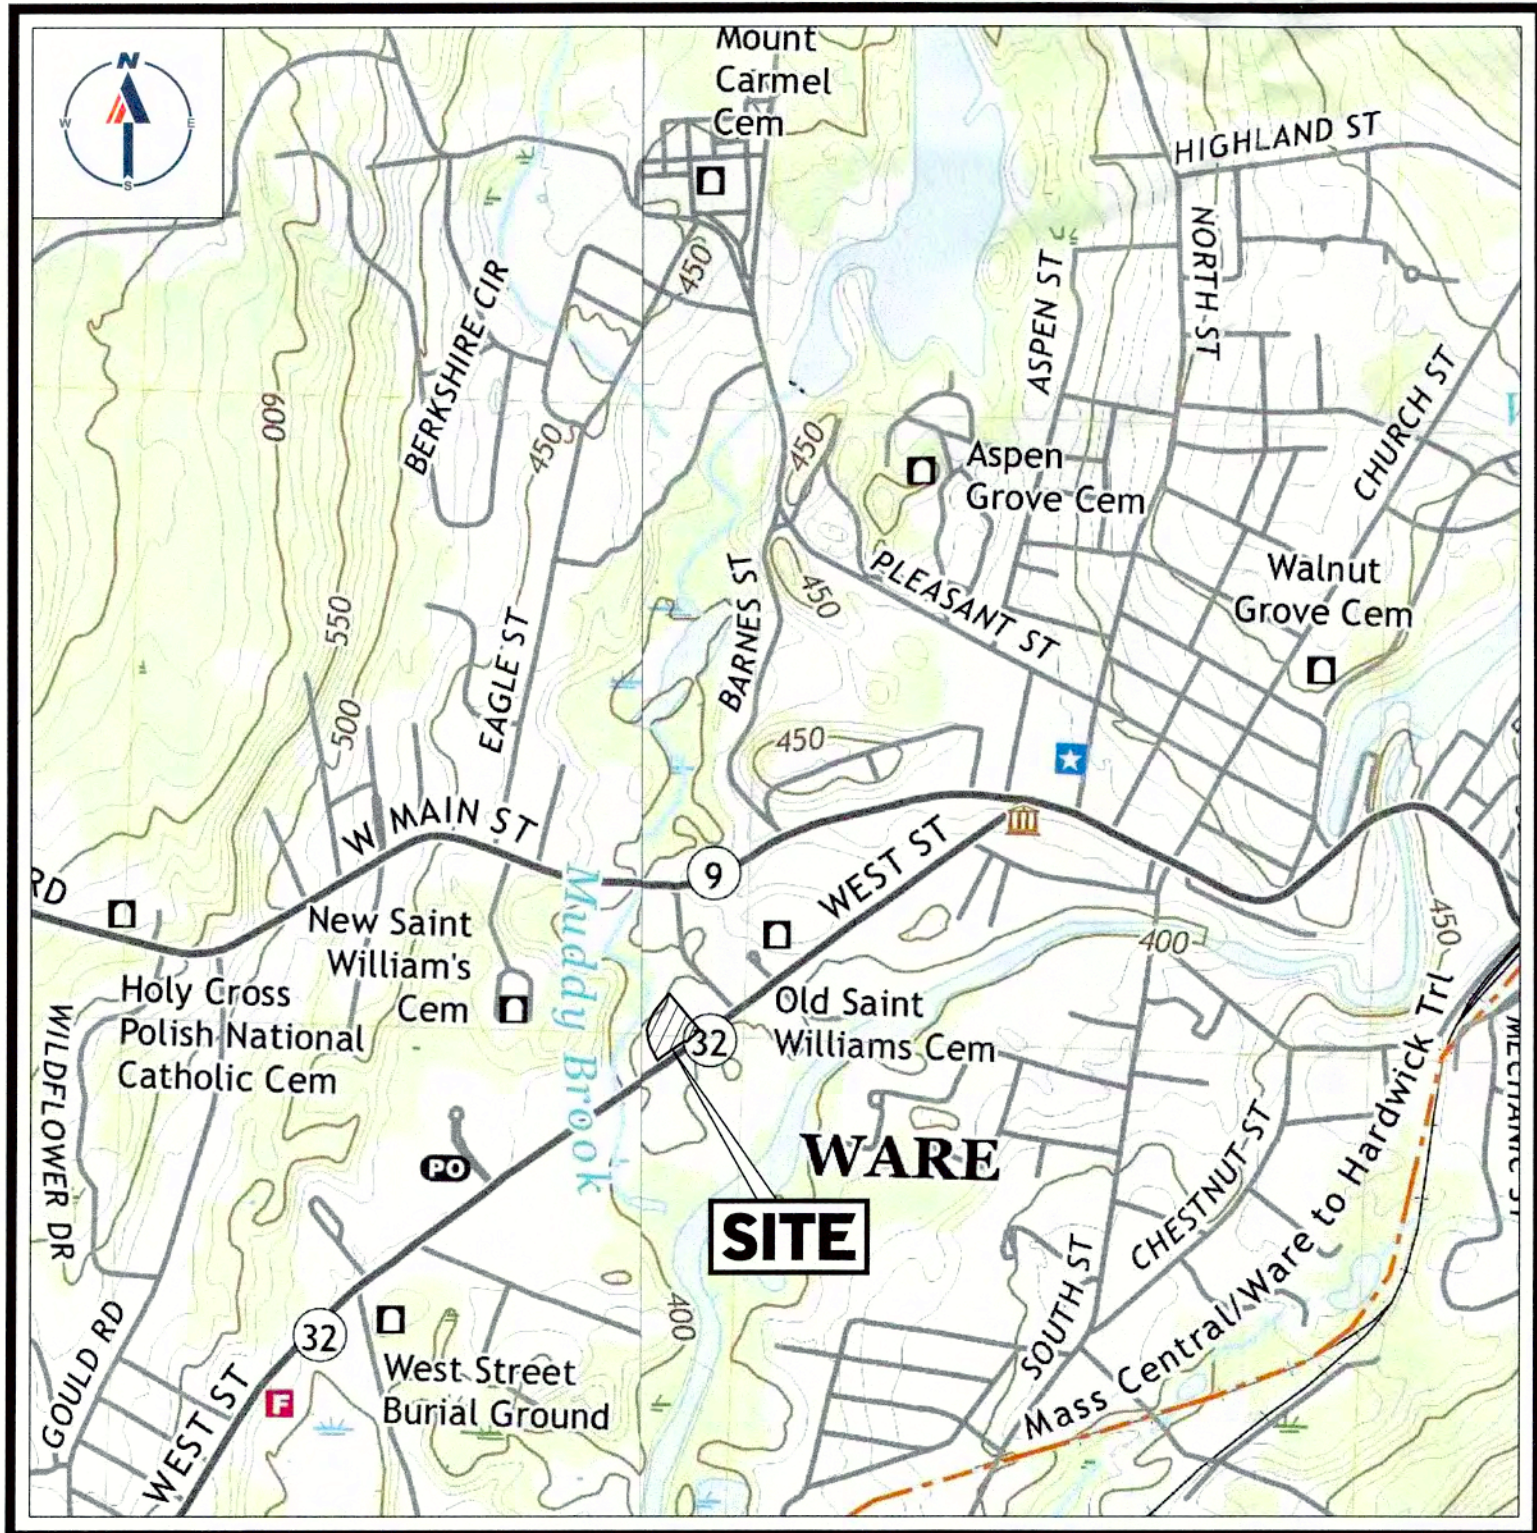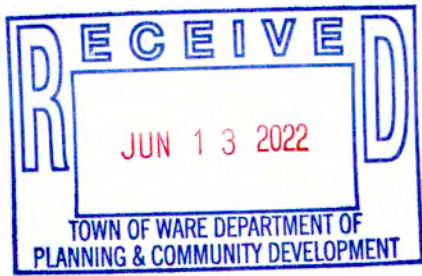

USGS MAP

SCALE: 1" = 1,000'
SOURCE: USGS WARE QUADRANGLE & WINSOR DAM QUADRANGLE



SITE MAP

SCALE: 1" = 100'
SOURCE: GOOGLE AERIAL

DRAWING SHEET INDEX

SHEET TITLE	SHEET NUMBER
COVER SHEET	C-101
GENERAL NOTES SHEET	C-102
DEMOLITION & EROSION CONTROL PLAN	C-201
SITE LAYOUT PLAN	C-301
GRADING AND DRAINAGE PLAN	C-401
DETAIL SHEET	C-901
DETAIL SHEET	C-902
BOUNDARY & TOPOGRAPHIC SURVEY (BY OTHERS)	1

GENERAL NOTES:

- BASES, ANCHOR BOLTS, CONDUIT, AND WIRING FOR ALL OTHER SIGNS ARE BY THE GENERAL CONTRACTOR.
- 3/4" EMPTY CONDUIT TO LOCATIONS SHOWN AT THE LOT PERIMETER FOR LOT LIGHTING IS BY THE GENERAL CONTRACTOR. LIGHTING FIXTURES, BASES, POLES, CONDUIT, AND WIRING ARE BY THE OWNER/OPERATOR.
- BASES FOR FLAGPOLES ARE BY THE GENERAL CONTRACTOR. ANCHOR BOLTS ARE BY THE FLAGPOLE SUPPLIER.
- PROPOSED UTILITIES ARE SHOWN IN SCHEMATIC ONLY. EXACT LOCATIONS SHALL BE DETERMINED TO ALLOW FOR THE MOST ECONOMICAL INSTALLATION.
- THE CONTRACTOR SHALL COORDINATE WITH ALL UTILITY COMPANIES TO DETERMINE EXACT POINT OF SERVICE CONNECTION AT EXISTING UTILITY. REFER TO THE BUILDING ELECTRICAL AND PLUMBING DRAWINGS FOR UTILITY SERVICE ENTRANCE LOCATIONS, SIZES, AND CIRCUITING.
- ALL ELEVATIONS SHOWN ARE BASED UPON, NAVD 88 PER SURVEY NOTE #7.
- ALL LANDSCAPE AREAS SHALL BE ROUGH GRADED TO 6" BELOW TOP OF ALL WALKS AND CURBS. FINISH GRADING, LANDSCAPING, AND SPRINKLER SYSTEMS ARE BY THE OWNER/OPERATOR.
- LOT LIGHTING CONCRETE FOOTINGS TO CONFORM WITH THE SOILS REPORT RECOMMENDATIONS FOR THIS PARTICULAR SITE. FOUNDATION DESIGN AND CONSTRUCTION IS BY THE GENERAL CONTRACTOR.

PAVING SPECIFICATION

(SEE PAVEMENT DETAIL)

FLEXIBLE PAVEMENT SECTION:
-1.5" M.04.02-CLASS 2 TOP COURSE
-1.5" M.04.02-CLASS 1 BASE COURSE
-12.0" M.02.06 TYPE C PROCESSED GRAVEL SUBBASE

RIGID PAVEMENT SECTION:
-6.0" 4500 PSI AIR-ENTRAINED CONCRETE
-8.0" 4500 PSI AIR-ENTRAINED CONCRETE AT TRASH ENCLOSURE
-12.0" M.02.06 TYPE C PROCESSED GRAVEL SUBBASE

NOTE: FINAL PAVEMENT SPECIFICATIONS TO BE COORDINATED WITH GEOTECHNICAL REPORT RECOMMENDATIONS. McDONALD'S ENGINEER RESERVES THE RIGHT TO REQUEST A COMPACTION TEST AND/OR A CORE SAMPLE. IF TESTS PROVE CORRECT, PER ABOVE SPECIFICATION, TESTS WILL BE AT THE EXPENSE OF McDONALD'S. OTHERWISE, G.C. WILL BE CHARGED.

PARKING INFORMATION

TOTAL SPACES	5	PROPOSED SPACES	9.0' x 14.6' @ 45°
	52	EXISTING SPACES	

UTILITY INFORMATION

	SIZE	TYPE	LOCATION
SANITARY SEWER	UNKNOWN	UG	ON-SITE / WEST STREET R.O.W.
WATER	UNKNOWN	UG	ON-SITE / WEST STREET R.O.W.
STORM SEWER	VARIES	VARIES	ON-SITE / WEST STREET R.O.W.
ELECTRIC	UNKNOWN	OH / UG	ON-SITE / WEST STREET R.O.W.
GAS	UNKNOWN	UNKNOWN	TANKS ON-SITE

SURVEY INFORMATION

PREPARED BY: CONTROL POINT ASSOCIATES, INC.
352 TURNPIKE ROAD
SOUTHBOROUGH, MA 01772
JOB #: 03-170294
DATE: FEBRUARY 12, 2018
REVISED: JUNE 13, 2018

TYPICAL LEGEND

EXISTING	PROPERTY LINE	PROPOSED
---	SETBACK	
---	EASEMENT	
---	CURB	
⊙	STORM MANHOLE	⊙
⊙	SEWER MANHOLE	⊙
⊙	CATCH BASIN	⊙
Δ	WETLAND FLAG	
WFL	WETLAND LINE	
×	SPOT ELEVATION	
×	TOP & BOTTOM OF CURB	
---	CONTOUR	---
→	FLOW ARROW	→
→	PAINTED ARROW	→
OH	OVERHEAD WIRE	OH
G	GAS LINE	G
T	TELEPHONE LINE	T
E	ELECTRIC LINE	E
W	WATER LINE	W

STREET ADDRESS
117-119 WEST STREET

CITY WARE STATE MA
COUNTY HAMPSHIRE

SITE I.D.
020-0107

PLAN DESCRIPTION
COVER SHEET

STATUS DATE BY
DRAWN BY: 02/04/22 CSE
PLAN CHECKED 02/04/22 JAK
AS-BUILT

SHEET NO.
C-101
OF 7

BOHLER

SITE CIVIL AND CONSULTING ENGINEERING
LAND SURVEYING
PROGRAM MANAGEMENT
LANDSCAPE ARCHITECTURE
SUSTAINABLE DESIGN
PERMITTING SERVICES
TRANSPORTATION SERVICES

COMPLIANCE CHECK DATE

CONSTRUCTION CHECK DATE

CONSTRUCTION CHECK DATE

PROJECT No.:
W212039

CAD I.D. #:
W212039-CVL-2.dwg

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BOSTON REGION

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CHICAGO, IL 60607




OFFICE ADDRESS

PLAN APPROVALS

SIGNATURE

DATE

APPROVED McDONALD'S AGENT

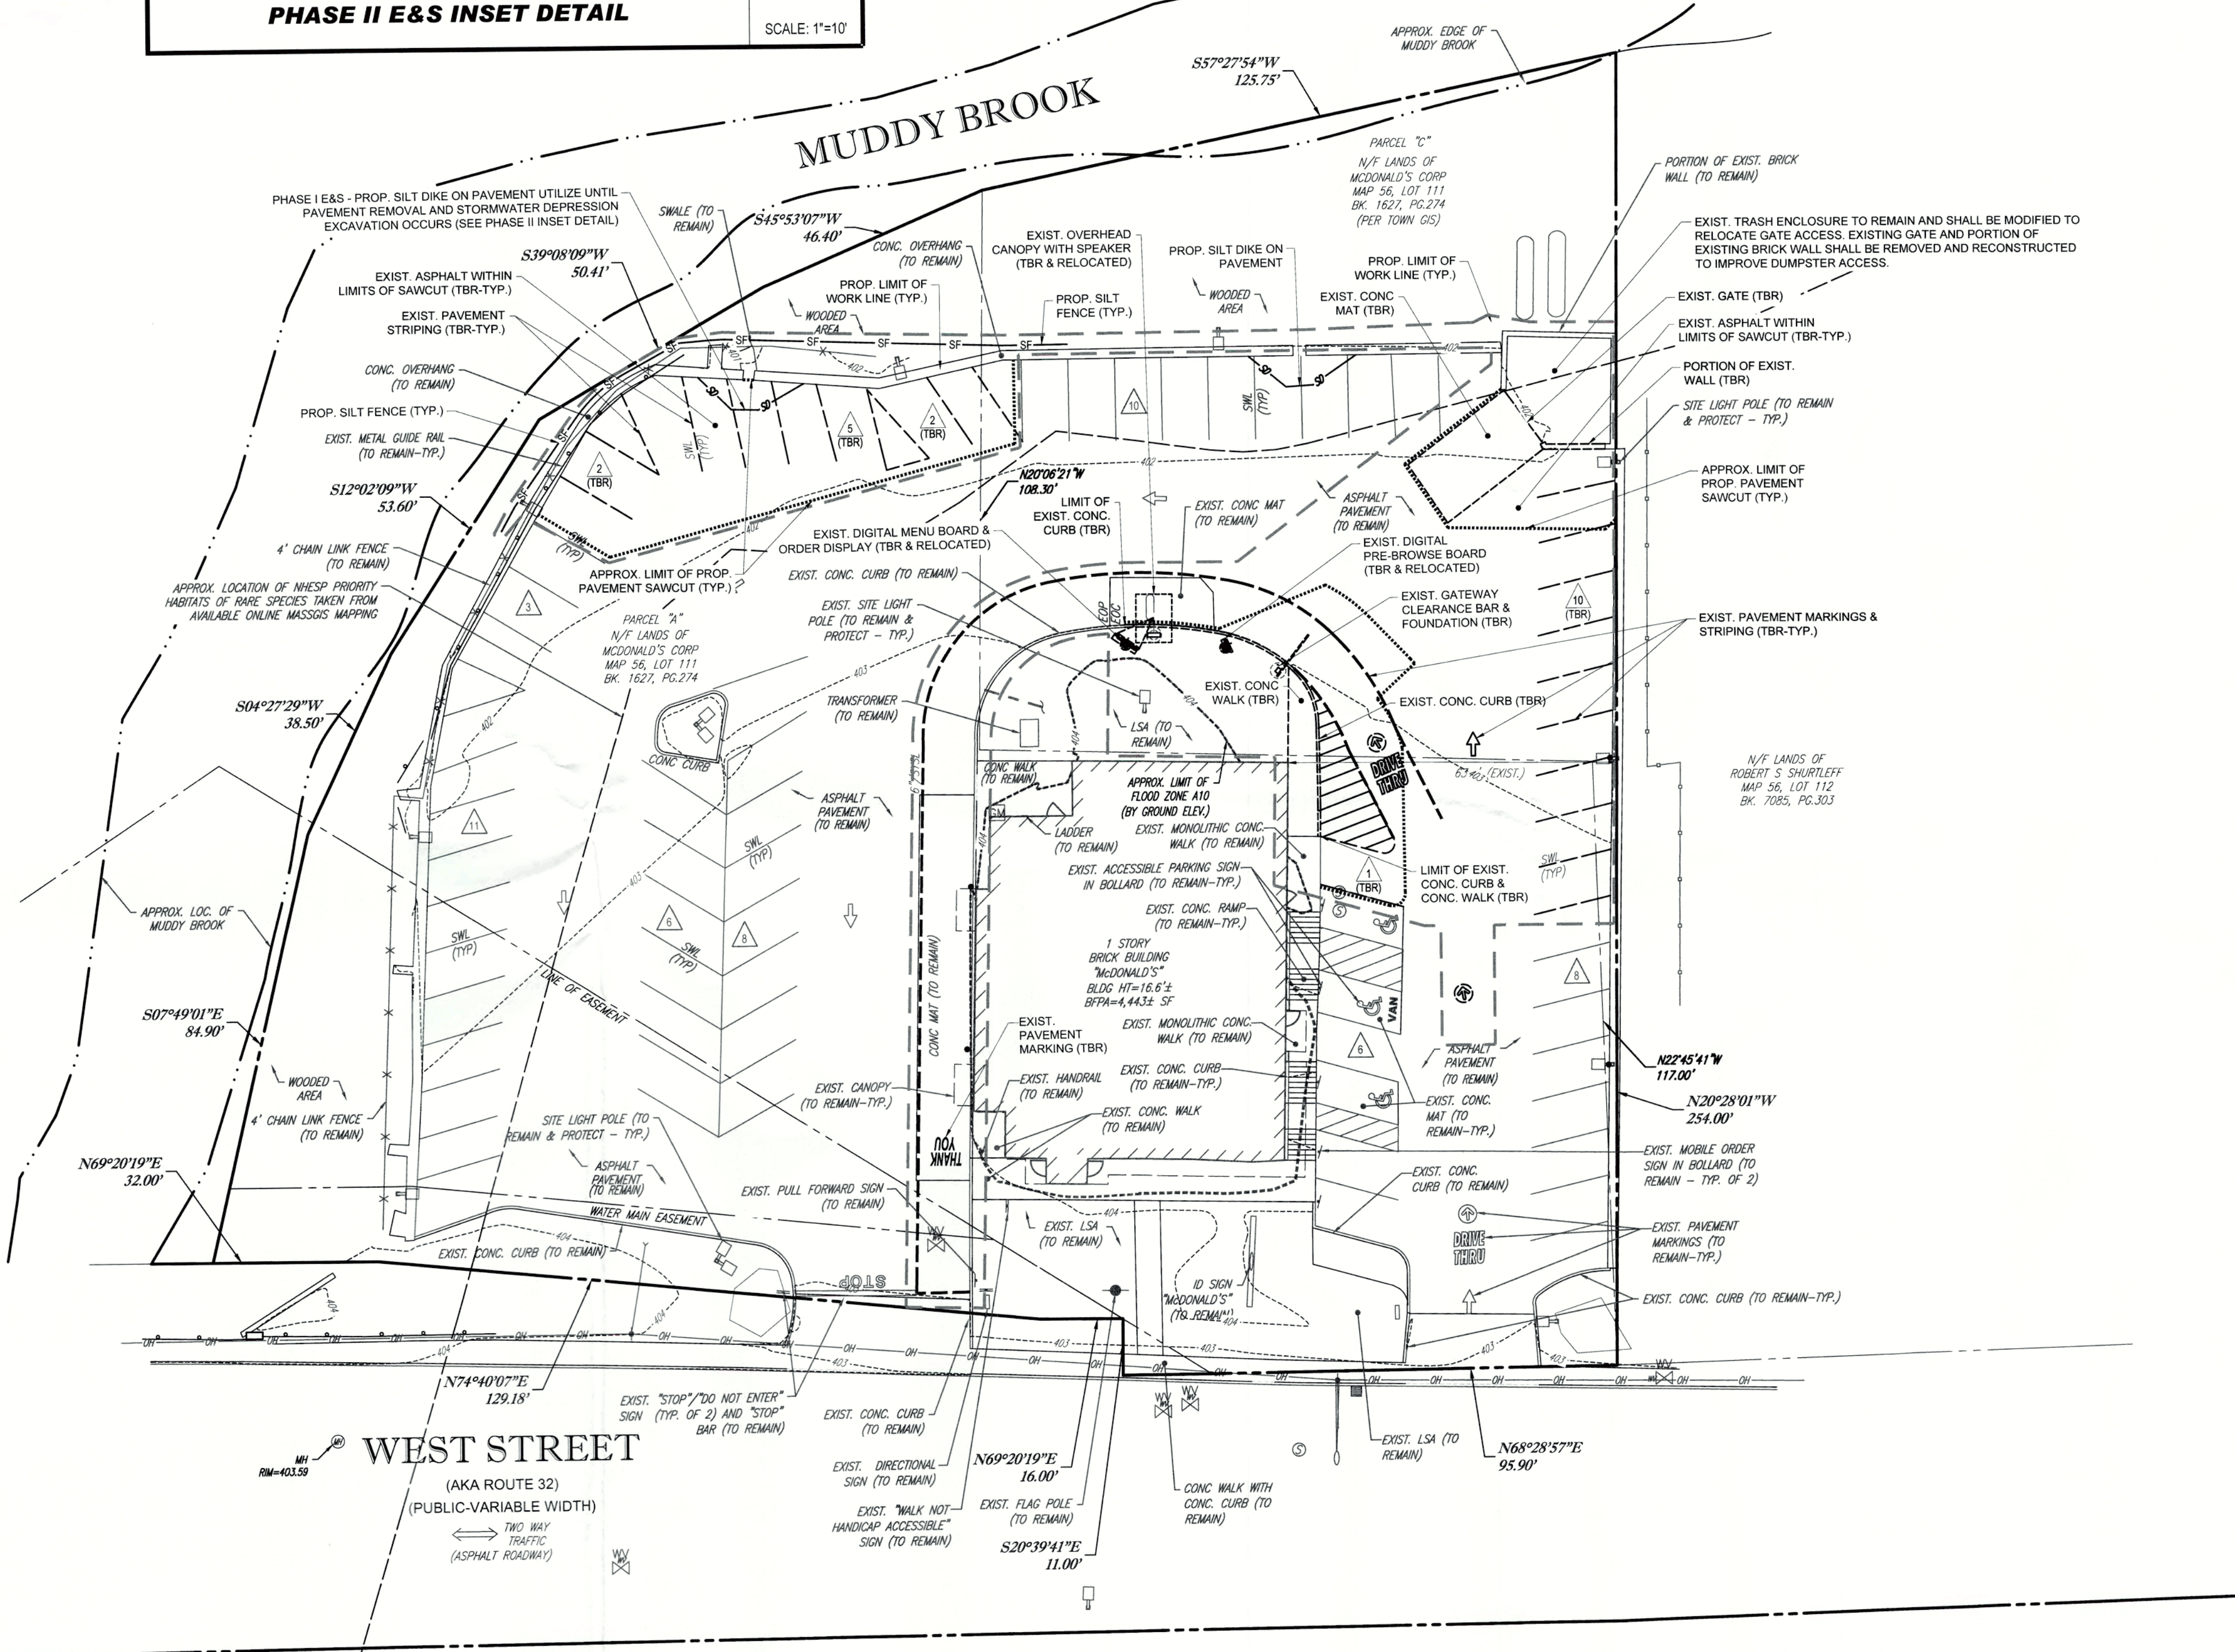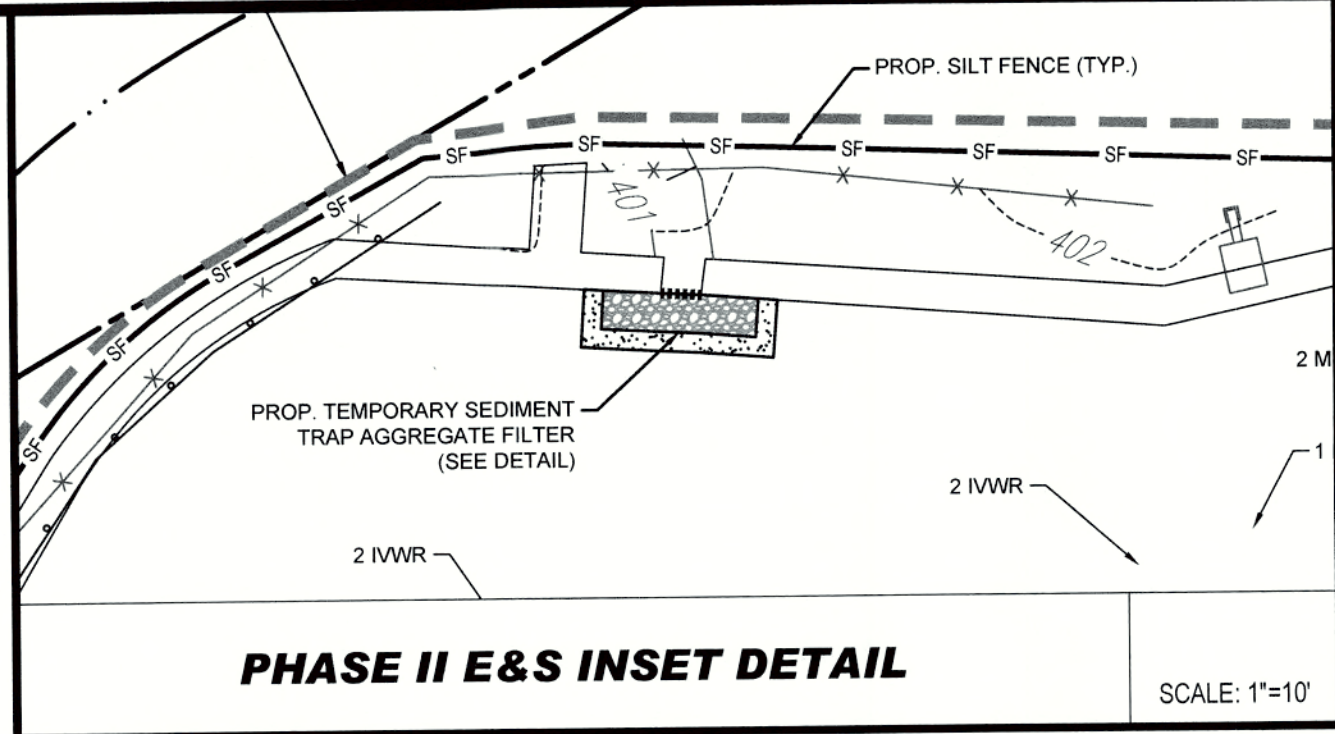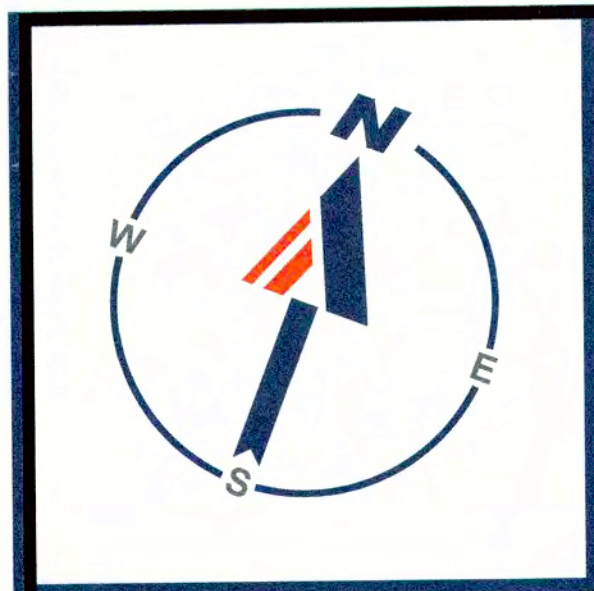

EROSION AND SEDIMENT CONTROL NOTES

- ALL SEDIMENT AND EROSION CONTROL MEASURES SHALL BE DONE AS SET FORTH IN THE MOST CURRENT STATE SEDIMENT AND EROSION CONTROL MANUAL.
- THOSE AREAS UNDERGOING ACTUAL CONSTRUCTION WILL BE LEFT IN AN UNTREATED OR UNVEGETATED CONDITION FOR A MINIMUM TIME. AREAS SHALL BE PERMANENTLY STABILIZED WITHIN 15 DAYS OF FINAL GRADING AND TEMPORARILY STABILIZED WITHIN 30 DAYS OF INITIAL DISTURBANCE OF THE SOIL. IF THE DISTURBANCE IS WITHIN 100 FEET OF A STREAM OR POND, THE AREA SHALL BE STABILIZED WITHIN 7 DAYS OR PRIOR TO ANY STORM EVENT (THIS WOULD INCLUDE WETLANDS).
- SEDIMENT BARRIERS (SILT FENCE, STRAW BARRIERS, ETC.) SHOULD BE INSTALLED PRIOR TO ANY SOIL DISTURBANCE OF THE CONTRIBUTING DRAINAGE AREA ABOVE THEM. MULCH NETTING SHALL BE USED TO ANCHOR MULCH IN ALL AREAS WITH SLOPES GREATER THAN 15% AFTER OCTOBER 1ST THE SAME APPLIES FOR ALL SLOPES GREATER THAN 8%.
- INSTALL SILTATION BARRIER AT TOE OF SLOPE TO FILTER SILT FROM RUNOFF. SEE SILTATION BARRIER DETAILS FOR PROPER INSTALLATION. SILTATION BARRIER WILL REMAIN IN PLACE PER NOTE #5.
- ALL EROSION CONTROL STRUCTURES WILL BE INSPECTED, REPLACED AND/OR REPAIRED EVERY 7 DAYS AND IMMEDIATELY FOLLOWING ANY SIGNIFICANT RAINFALL OR SNOW MELT OR WHEN NO LONGER SERVICEABLE DUE TO SEDIMENT ACCUMULATION OR DECOMPOSITION. SEDIMENT DEPOSITS SHOULD BE REMOVED AFTER EACH STORM EVENT. THEY MUST BE REMOVED WHEN DEPOSITS REACH APPROXIMATELY ONE HALF THE HEIGHT OF THE BARRIER. SEDIMENT CONTROL DEVICES SHALL REMAIN IN PLACE AND BE MAINTAINED BY THE CONTRACTOR UNTIL AREAS UPLOPE ARE STABILIZED BY TURF.
- NO SLOPES, EITHER PERMANENT OR TEMPORARY, SHALL BE STEEPER THAN TWO TO ONE (2:1).
- IF FINAL SEEDING OF THE DISTURBED AREAS IS NOT COMPLETED 45 DAYS PRIOR TO THE FIRST KILLING FROST, USE TEMPORARY MULCH (DORMANT SEEDING MAY BE ATTEMPTED AS WELL) TO PROTECT THE SITE AND DELAY SEEDING UNTIL THE NEXT RECOMMENDED SEEDING PERIOD.
- TEMPORARY SEEDING OF DISTURBED AREAS THAT HAVE NOT BEEN FINAL GRADED SHALL BE COMPLETED 45 DAYS PRIOR TO THE FIRST KILLING FROST TO PROTECT FROM SPRING RUNOFF PROBLEMS.
- DURING THE CONSTRUCTION PHASE, INTERCEPTED SEDIMENT WILL BE RETURNED TO THE SITE AND REGRADED ONTO OPEN AREAS.
- REVEGETATION MEASURES WILL COMMENCE UPON COMPLETION OF CONSTRUCTION EXCEPT AS NOTED ABOVE. ALL DISTURBED AREAS NOT OTHERWISE STABILIZED WILL BE GRADED, SMOOTHED, AND PREPARED FOR FINAL SEEDING AS FOLLOWS:
 - SIX INCHES OF LOAM WILL BE SPREAD OVER DISTURBED AREAS AND SMOOTHED TO A UNIFORM SURFACE.
 - APPLY LIMESTONE AND FERTILIZER ACCORDING TO SOIL TEST. IF SOIL TESTING IS NOT FEASIBLE ON SMALL OR VARIABLE SITES, OR WHERE TIMING IS CRITICAL, FERTILIZER MAY BE APPLIED AT THE RATE OF 800 LB PER ACRE OR 18.4 LB PER 1,000 SF USING 10-20-20 OR EQUIVALENT. APPLY GROUND LIMESTONE (EQUIVALENT TO 50% CALCIUM PLUS MAGNESIUM OXIDE) AT A RATE OF 3 TONS PER ACRE (138 LB PER 1,000 SF).
 - FOLLOWING SEED BED PREPARATION, DITCHES AND BACK SLOPES WILL BE SEED TO A MIXTURE OF 47% CREEPING RED FESCUE, 5% REDTOP, AND 48% TALL FESCUE. THE LAWN AREAS WILL BE SEED TO A PREMIUM TURF MIXTURE OF 44% KENTUCKY BLUEGRASS, 44% CREEPING RED FESCUE, AND 12% PERENNIAL RYEGRASS. SEEDING RATE IS 1.03 LBS PER 1,000 SF LAWN QUALITY SOD MAY BE SUBSTITUTED FOR SEED.
 - STRAW MULCH AT THE RATE OF 70-80 LBS PER 1,000 SF. A HYDRO-APPLICATION OF WOOD OR PAPER FIBER SHALL BE APPLIED FOLLOWING SEEDING. A SUITABLE BINDER SUCH AS CURASOL OR RMB PLUS WILL BE USED ON STRAW MULCH FOR WIND CONTROL.
- ALL TEMPORARY EROSION CONTROL MEASURES SHALL BE REMOVED ONCE THE SITE IS STABILIZED.
- WETLANDS WILL BE PROTECTED WITH STRAW, COMPOST, AND/OR SILT FENCE BARRIERS INSTALLED AT THE EDGE OF THE WETLAND OR THE BOUNDARY OF WETLAND DISTURBANCE.
- ALL AREAS WITHIN 100 FEET OF A FLAGGED WETLAND OR STREAM SHALL HAVE AN EXPOSURE WINDOW OF NOT MORE THAN 7 DAYS.
- ALL AREAS WITHIN 100 FEET OF A FLAGGED WETLAND OR STREAM SHALL FOLLOW APPROPRIATE EROSION CONTROL MEASURES PRIOR TO EACH STORM IF NOT BEING ACTIVELY WORKED.


MULCH		
LOCATION	MULCH	RATE (1000 SF)
PROTECT AREA	STRAW	100 POUNDS
WINDY AREA	SHREDDED OR CHOPPED CORNSTALKS	185-275 POUNDS
	STRAW (ANCHORED)*	100 POUNDS
MODERATE TO HIGH VELOCITY AREAS OR STEEP SLOPES GREATER THAN 3:1	JUTE MESH OR EXCELSIOR MAT	AS REQUIRED
	GREATER THAN 3:1	(REFER TO GEOTECHNICAL REPORT FOR FINAL DESIGN REQUIREMENT)

* A HYDRO-APPLICATION OF WOOD, OR PAPER FIBER MAY BE APPLIED FOLLOWING SEEDING. A SUITABLE BINDER SUCH AS CURASOL OR RMB PLUS SHALL BE USED ON STRAW MULCH FOR WIND CONTROL.

MULCH ANCHORING:
ANCHOR MULCH WITH PEG AND TWINE (1 SQ. YD/BLOCK). MULCH NETTING (AS PER MANUFACTURER); WOOD CELLULOSE FIBER (750 LBS/ACRE); CHEMICAL TACK (AS PER MANUFACTURER'S SPECIFICATIONS); USE OF A SERRATED STRAIGHT DISK. WETTING FOR SMALL AREAS AND ROAD DITCHES MAY BE PERMITTED.

EROSION CONTROL NOTES DURING WINTER CONSTRUCTION

- WINTER CONSTRUCTION PERIOD: NOVEMBER 1 THROUGH APRIL 15.
- WINTER EXCAVATION AND EARTHWORK SHALL BE DONE SUCH THAT NO MORE THAN 1 ACRE OF THE SITE IS WITHOUT STABILIZATION AT ANY ONE TIME.
- EXPOSED AREA SHOULD BE LIMITED TO THAT WHICH CAN BE MULCHED IN ONE DAY PRIOR TO ANY SNOW EVENT.
- CONTINUATION OF EARTHWORK OPERATION ON ADDITIONAL AREAS SHALL NOT BEGIN UNTIL THE EXPOSED SOIL SURFACE ON THE AREA BEING WORKED HAS BEEN STABILIZED SUCH THAT NO LARGER AREA OF THE SITE IS WITHOUT EROSION CONTROL PROTECTION AS LISTED IN ITEM 2 ABOVE.
- AN AREA SHALL BE CONSIDERED TO HAVE BEEN STABILIZED WHEN EXPOSED SURFACES HAVE BEEN EITHER MULCHED WITH STRAW OR STRAW AT A RATE OF 100 LB PER 1,000 SQUARE FEET (WITH OR WITHOUT SEEDING) OR DORMANT SEEDING, MULCHED AND ADEQUATELY ANCHORED BY AN APPROVED ANCHORING TECHNIQUE.
- BETWEEN THE DATES OF OCTOBER 15 AND APRIL 1ST, LOAM OR SEED WILL NOT BE REQUIRED. DURING PERIODS OF ABOVE FREEZING TEMPERATURES THE SLOPES SHALL BE FINE GRADED AND EITHER PROTECTED WITH MULCH OR TEMPORARILY SEEDED AND MULCHED UNTIL SUCH TIME AS THE FINAL TREATMENT CAN BE APPLIED. IF THE DATE IS AFTER NOVEMBER 1ST AND IF THE EXPOSED AREA HAS BEEN LOAMED, FINAL GRADED AND IS SMOOTH, THEN THE AREA MAY BE DORMANT SEEDING AT A RATE OF 200 - 300% HIGHER THAN SPECIFIED FOR PERMANENT SEED AND THEN MULCHED. IF CONSTRUCTION CONTINUES DURING FREEZING WEATHER, ALL EXPOSED AREAS SHALL BE CONTINUOUSLY GRADED BEFORE FREEZING AND THE SURFACE TEMPORARILY PROTECTED FROM EROSION BY THE APPLICATION OF MULCH. SLOPES SHALL NOT BE LEFT UNEXPOSED OVER THE WINTER OR ANY OTHER EXTENDED TIME OF WORK SUSPENSION UNLESS TREATED IN THE ABOVE MANNER. UNTIL SUCH TIME AS WEATHER CONDITIONS ALLOW DITCHES TO BE FINISHED WITH THE PERMANENT SURFACE TREATMENT, EROSION SHALL BE CONTROLLED BY THE INSTALLATION OF BALES OF STRAW OR STONE CHECK DAMS IN ACCORDANCE WITH THE STANDARD DETAILS.
- MULCHING REQUIREMENTS:
 - BETWEEN THE DATES OF NOVEMBER 1ST AND APRIL 15TH ALL MULCH SHALL BE ANCHORED BY EITHER PEG LINE, MULCH NETTING OR WOOD CELLULOSE FIBER.
 - MULCH NETTING SHALL BE USED TO ANCHOR MULCH IN ALL DRAINAGE WAYS WITH A SLOPE GREATER THAN 3% FOR SLOPE EXPOSED TO DIRECT WINDS AND FOR ALL OTHER SLOPES GREATER THAN 8%.
 - MULCH NETTING SHALL BE USED TO ANCHOR MULCH IN ALL AREAS WITH SLOPES GREATER THAN 15% AFTER OCTOBER 1ST THE SAME APPLIES FOR ALL SLOPES GREATER THAN 8%.
- AFTER NOVEMBER 1ST THE CONTRACTOR SHALL APPLY DORMANT SEEDING OR MULCH AND ANCHORING ON ALL BARE EARTH AT THE END OF EACH WORKING DAY.
- DURING THE WINTER CONSTRUCTION PERIOD ALL SNOW SHALL BE REMOVED FROM AREAS OF SEEDING AND MULCHING PRIOR TO PLACEMENT.
- STOCKPILING OF MATERIALS (DIRT, WOOD, CONSTRUCTION MATERIALS, ETC.) MUST REMAIN COVERED AT ALL TIMES TO MINIMIZE ANY DUST PROBLEMS THAT MAY OCCUR WITH ADJACENT PROPERTIES AND TO PROVIDE MAXIMUM PROTECTION AGAINST EROSION RUNOFF.
- EXISTING CATCH BASIN STRUCTURES SHALL BE PROTECTED UNTIL SUCH TIME AS THEY ARE REMOVED.

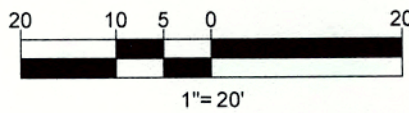

REFER TO GENERAL NOTES SHEET FOR DEMOLITION NOTES

THIS PLAN TO BE UTILIZED FOR DEMOLITION/ REMOVAL & SOIL EROSION CONTROL PURPOSES ONLY

BOHLER

SITE CIVIL AND CONSULTING ENGINEERING
LAND SURVEYING
PROGRAM MANAGEMENT
LANDSCAPE ARCHITECTURE
SUSTAINABLE DESIGN
PERMITTING SERVICES
TRANSPORTATION SERVICES

COMPLIANCE CHECK DATE

CONSTRUCTION CHECK DATE

CONSTRUCTION CHECK DATE

PROJECT No.:

W212039

CAD I.D. #:

W212039-CVL-2.dwg

STREET ADDRESS
117-119 WEST STREET

CITY
WARE

STATE
MA

COUNTY
HAMPSHIRE

SITE I.D.

020-0107

PLAN DESCRIPTION

DEMOLITION & EROSION CONTROL PLAN

SHEET No.

C-201

OF 7



Know what's below.
Call before you dig.

THE LOCATIONS OF EXISTING UNDERGROUND UTILITIES ARE SHOWN IN AN APPROXIMATE WAY ONLY AND HAVE NOT BEEN INDEPENDENTLY VERIFIED BY THE OWNER OR ITS REPRESENTATIVE. THE CONTRACTOR SHALL DETERMINE THE EXACT LOCATION OF ALL EXISTING UTILITIES BEFORE COMMENCING WORK, AND AGREES TO BE FULLY RESPONSIBLE FOR ANY AND ALL DAMAGES WHICH MIGHT BE OCCASIONED BY THE CONTRACTOR'S FAILURE TO EXACTLY LOCATE AND PRESERVE ANY AND ALL UNDERGROUND UTILITIES.


DESCRIPTION		DATE	REV
REVISED PER CONSERVATION COMMISSION COMMENTS	CSE	05/10/2022	1
REVISED PER CONSERVATION COMMISSION COMMENTS	CSE	06/09/2022	2

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BOSTON REGION
110 N CARPENTER ST
CHICAGO, IL 60607

PLAN APPROVALS		DATE	SIGNATURE	APPROVED MCDONALD'S AGENT
STATUS		DATE	BY	
DRAWN BY:		02/04/22	CSE	
PLAN CHECKED		02/04/22	JAK	
AS-BUILT				
SHEET No.		C-201		
		OF 7		



THIS PLAN TO BE UTILIZED FOR SITE GRADING PURPOSES ONLY. REFER TO GENERAL NOTES SHEET FOR ADDITIONAL GRADING & UTILITY NOTES

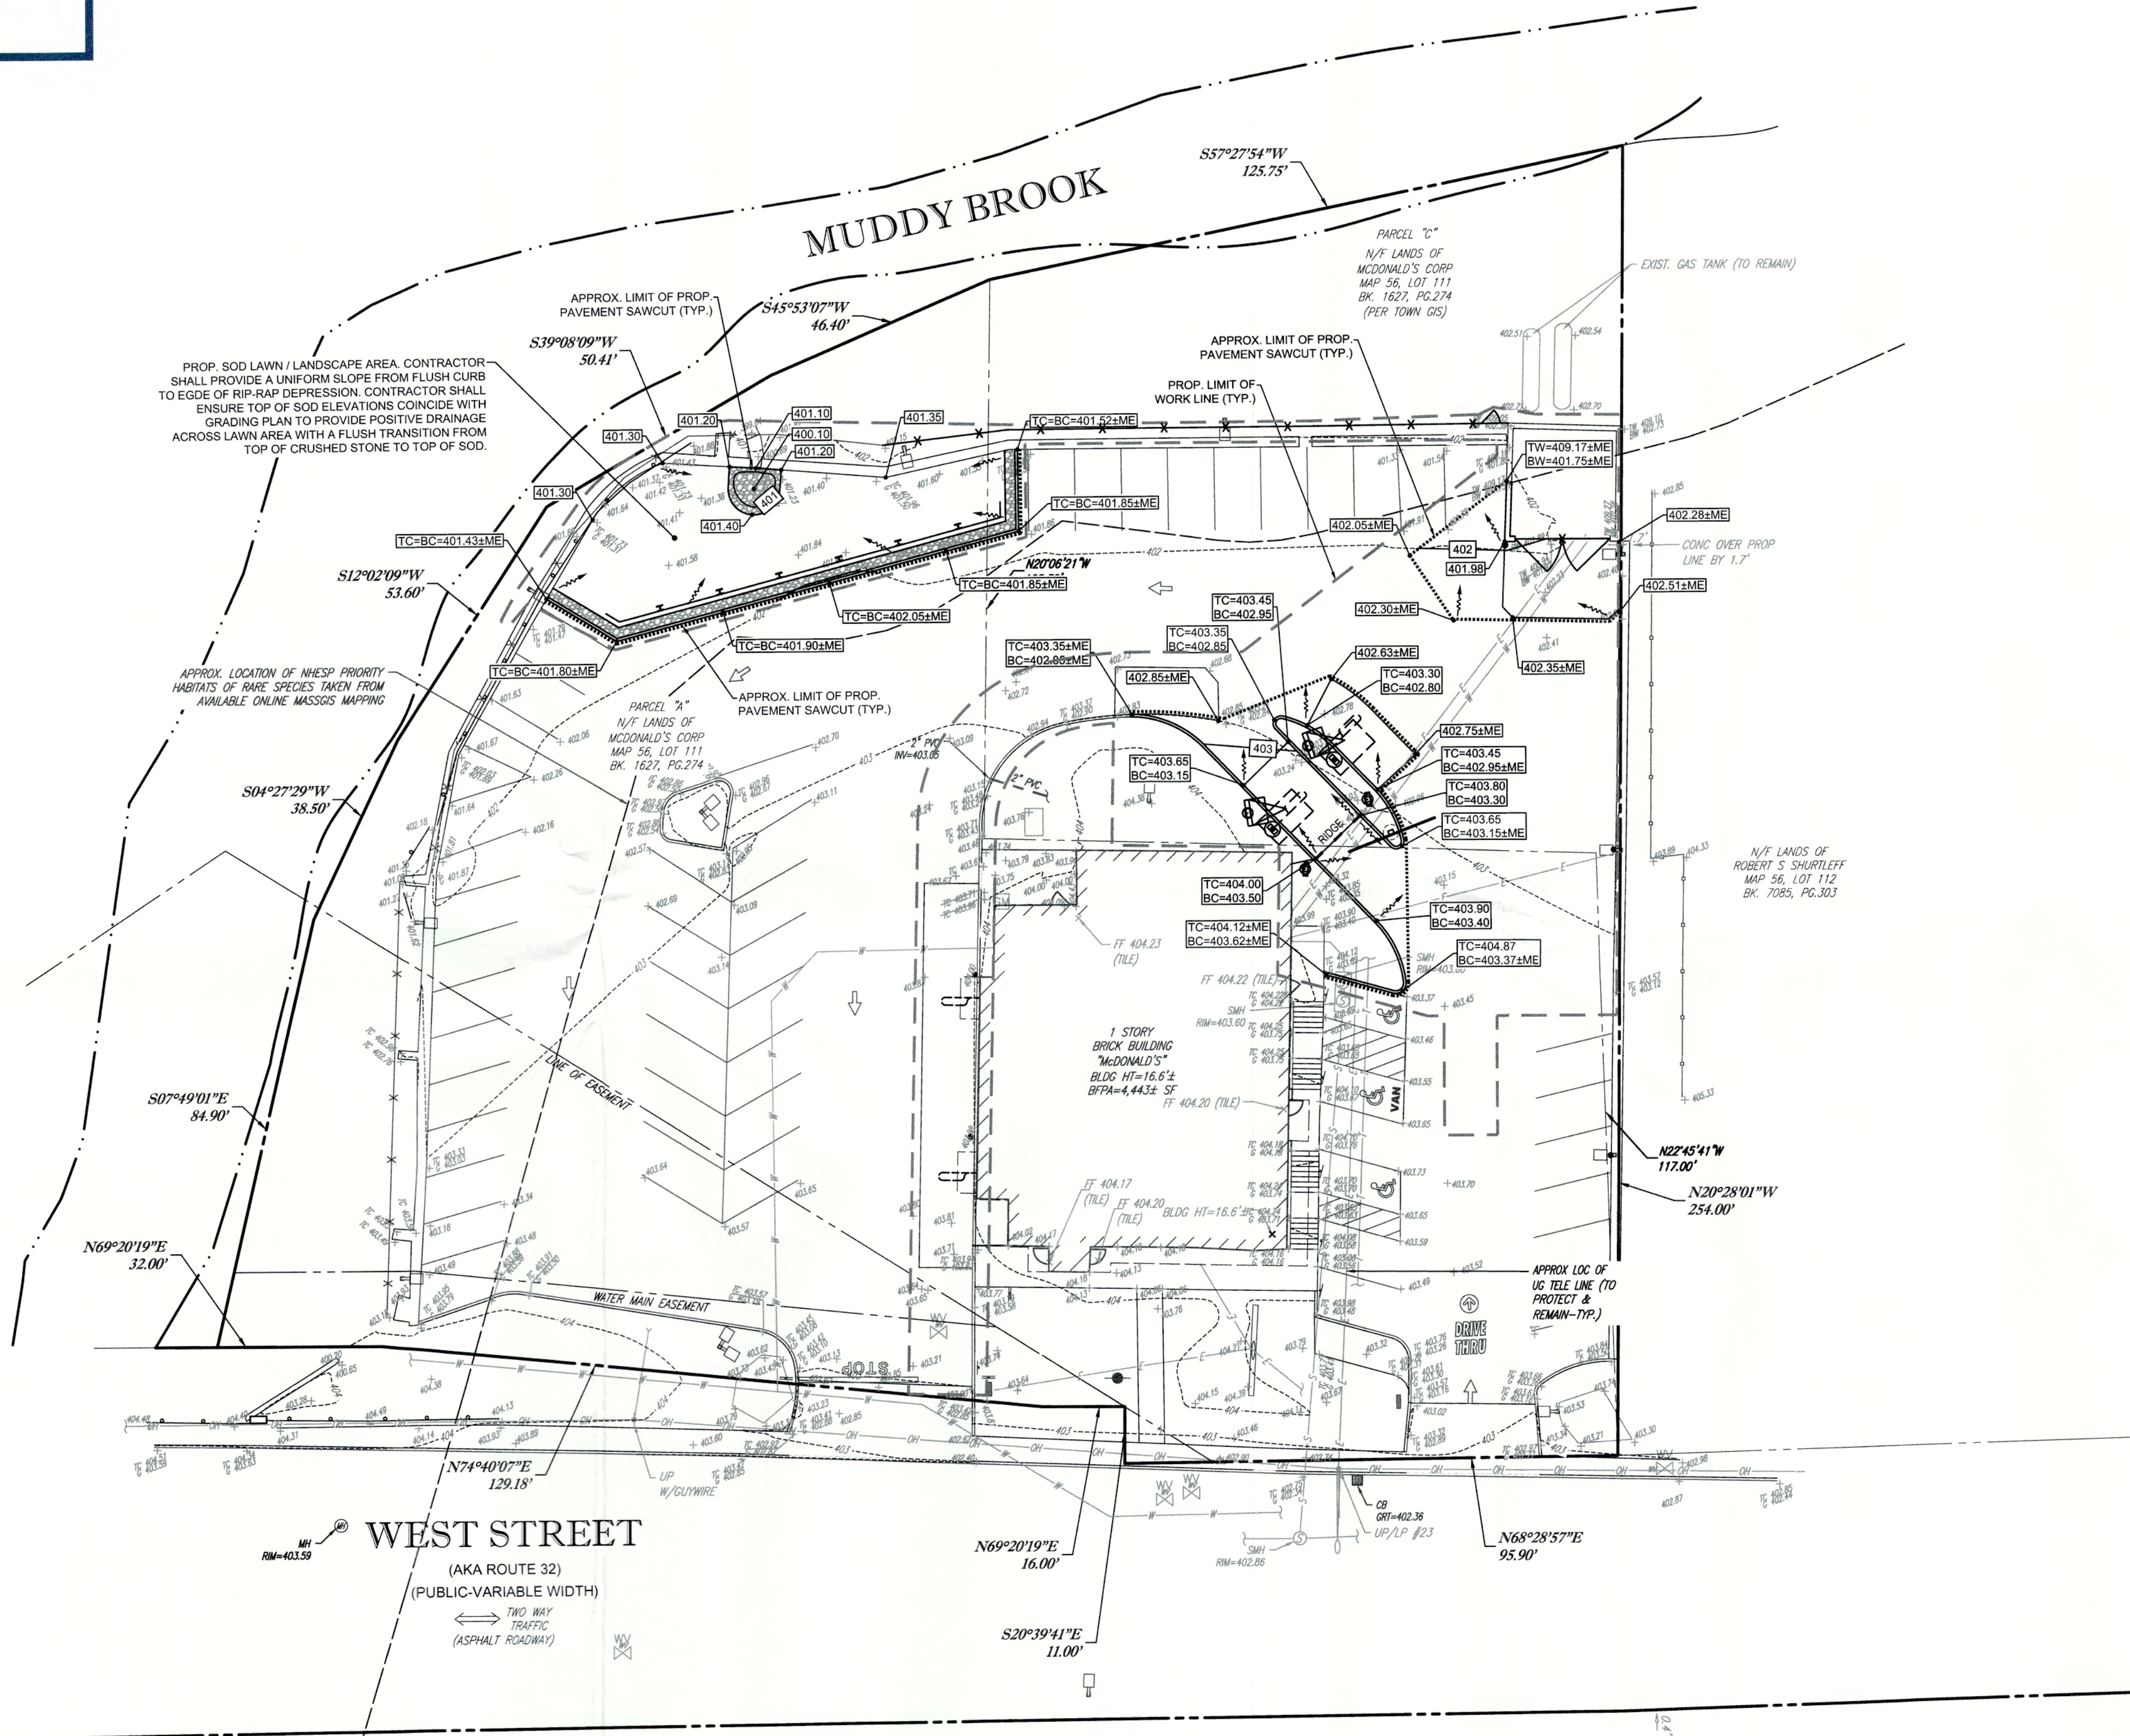

THE LOCATIONS OF EXISTING UNDERGROUND UTILITIES ARE SHOWN IN AN APPROXIMATE WAY ONLY AND HAVE NOT BEEN INDEPENDENTLY VERIFIED BY THE OWNER OR ITS REPRESENTATIVE. THE CONTRACTOR SHALL DETERMINE THE EXACT LOCATION OF ALL EXISTING UTILITIES BEFORE COMMENCING WORK, AND AGREES TO BE FULLY RESPONSIBLE FOR ANY AND ALL DAMAGES WHICH MIGHT BE OCCASIONED BY THE CONTRACTOR'S FAILURE TO EXACTLY LOCATE AND PRESERVE ANY AND ALL UNDERGROUND UTILITIES.


BOHLERTM

SITE CIVIL AND CONSULTING ENGINEERING
LAND SURVEYING
PROGRAM MANAGEMENT
LANDSCAPE ARCHITECTURE
SUSTAINABLE DESIGN
PERMITTING SERVICES
TRANSPORTATION SERVICES

COMPLIANCE CHECK	DATE
CONSTRUCTION CHECK	DATE
CONSTRUCTION CHECK	DATE
PROJECT No.:	W212039
CAD I.D. #:	W212039-CVL-2.dwg

STREET ADDRESS 117-119 WEST STREET	
CITY WARE	STATE MA
COUNTY HAMPSHIRE	
SITE I.D. 020-0107	PLAN DESCRIPTION GRADING AND DRAINAGE PLAN

STATUS	DATE	BY
DRAWN BY:	02/04/22	CSE
PLAN CHECKED	02/04/22	JAK
AS-BUILT		
SHEET NO.	C-401 OF 7	

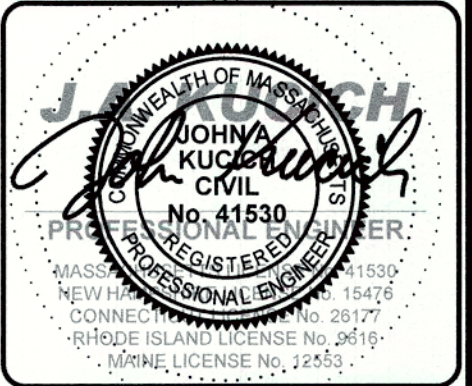

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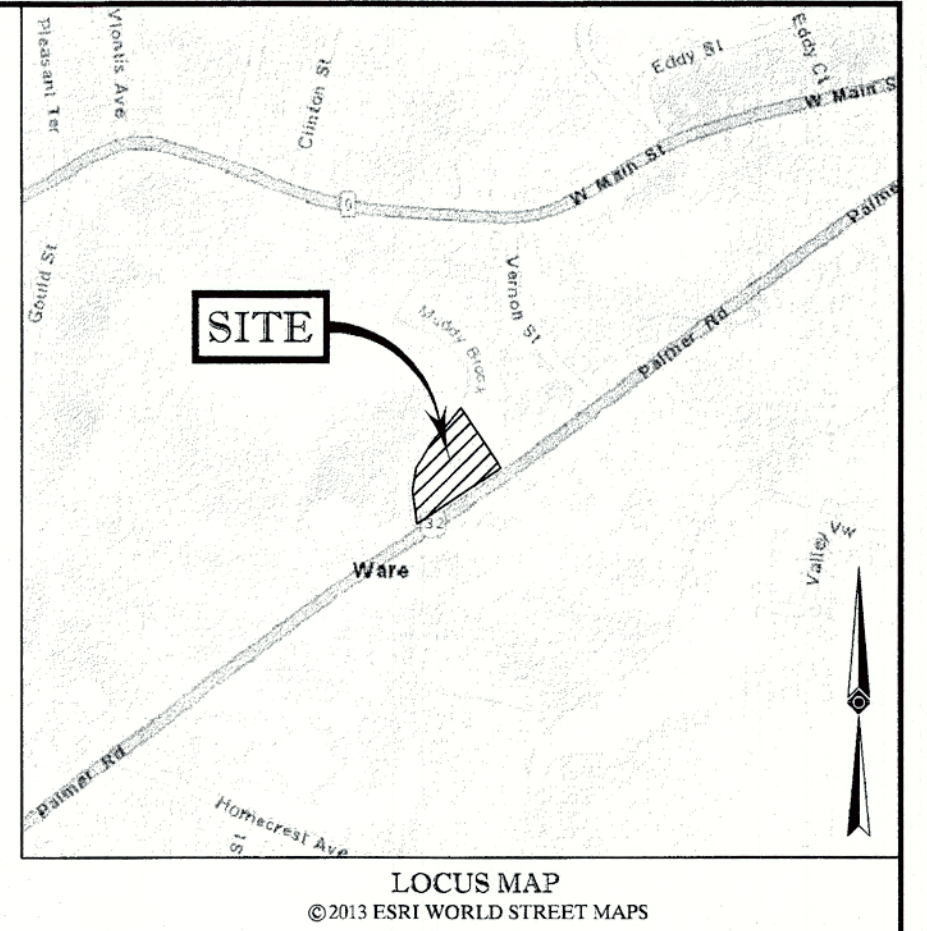
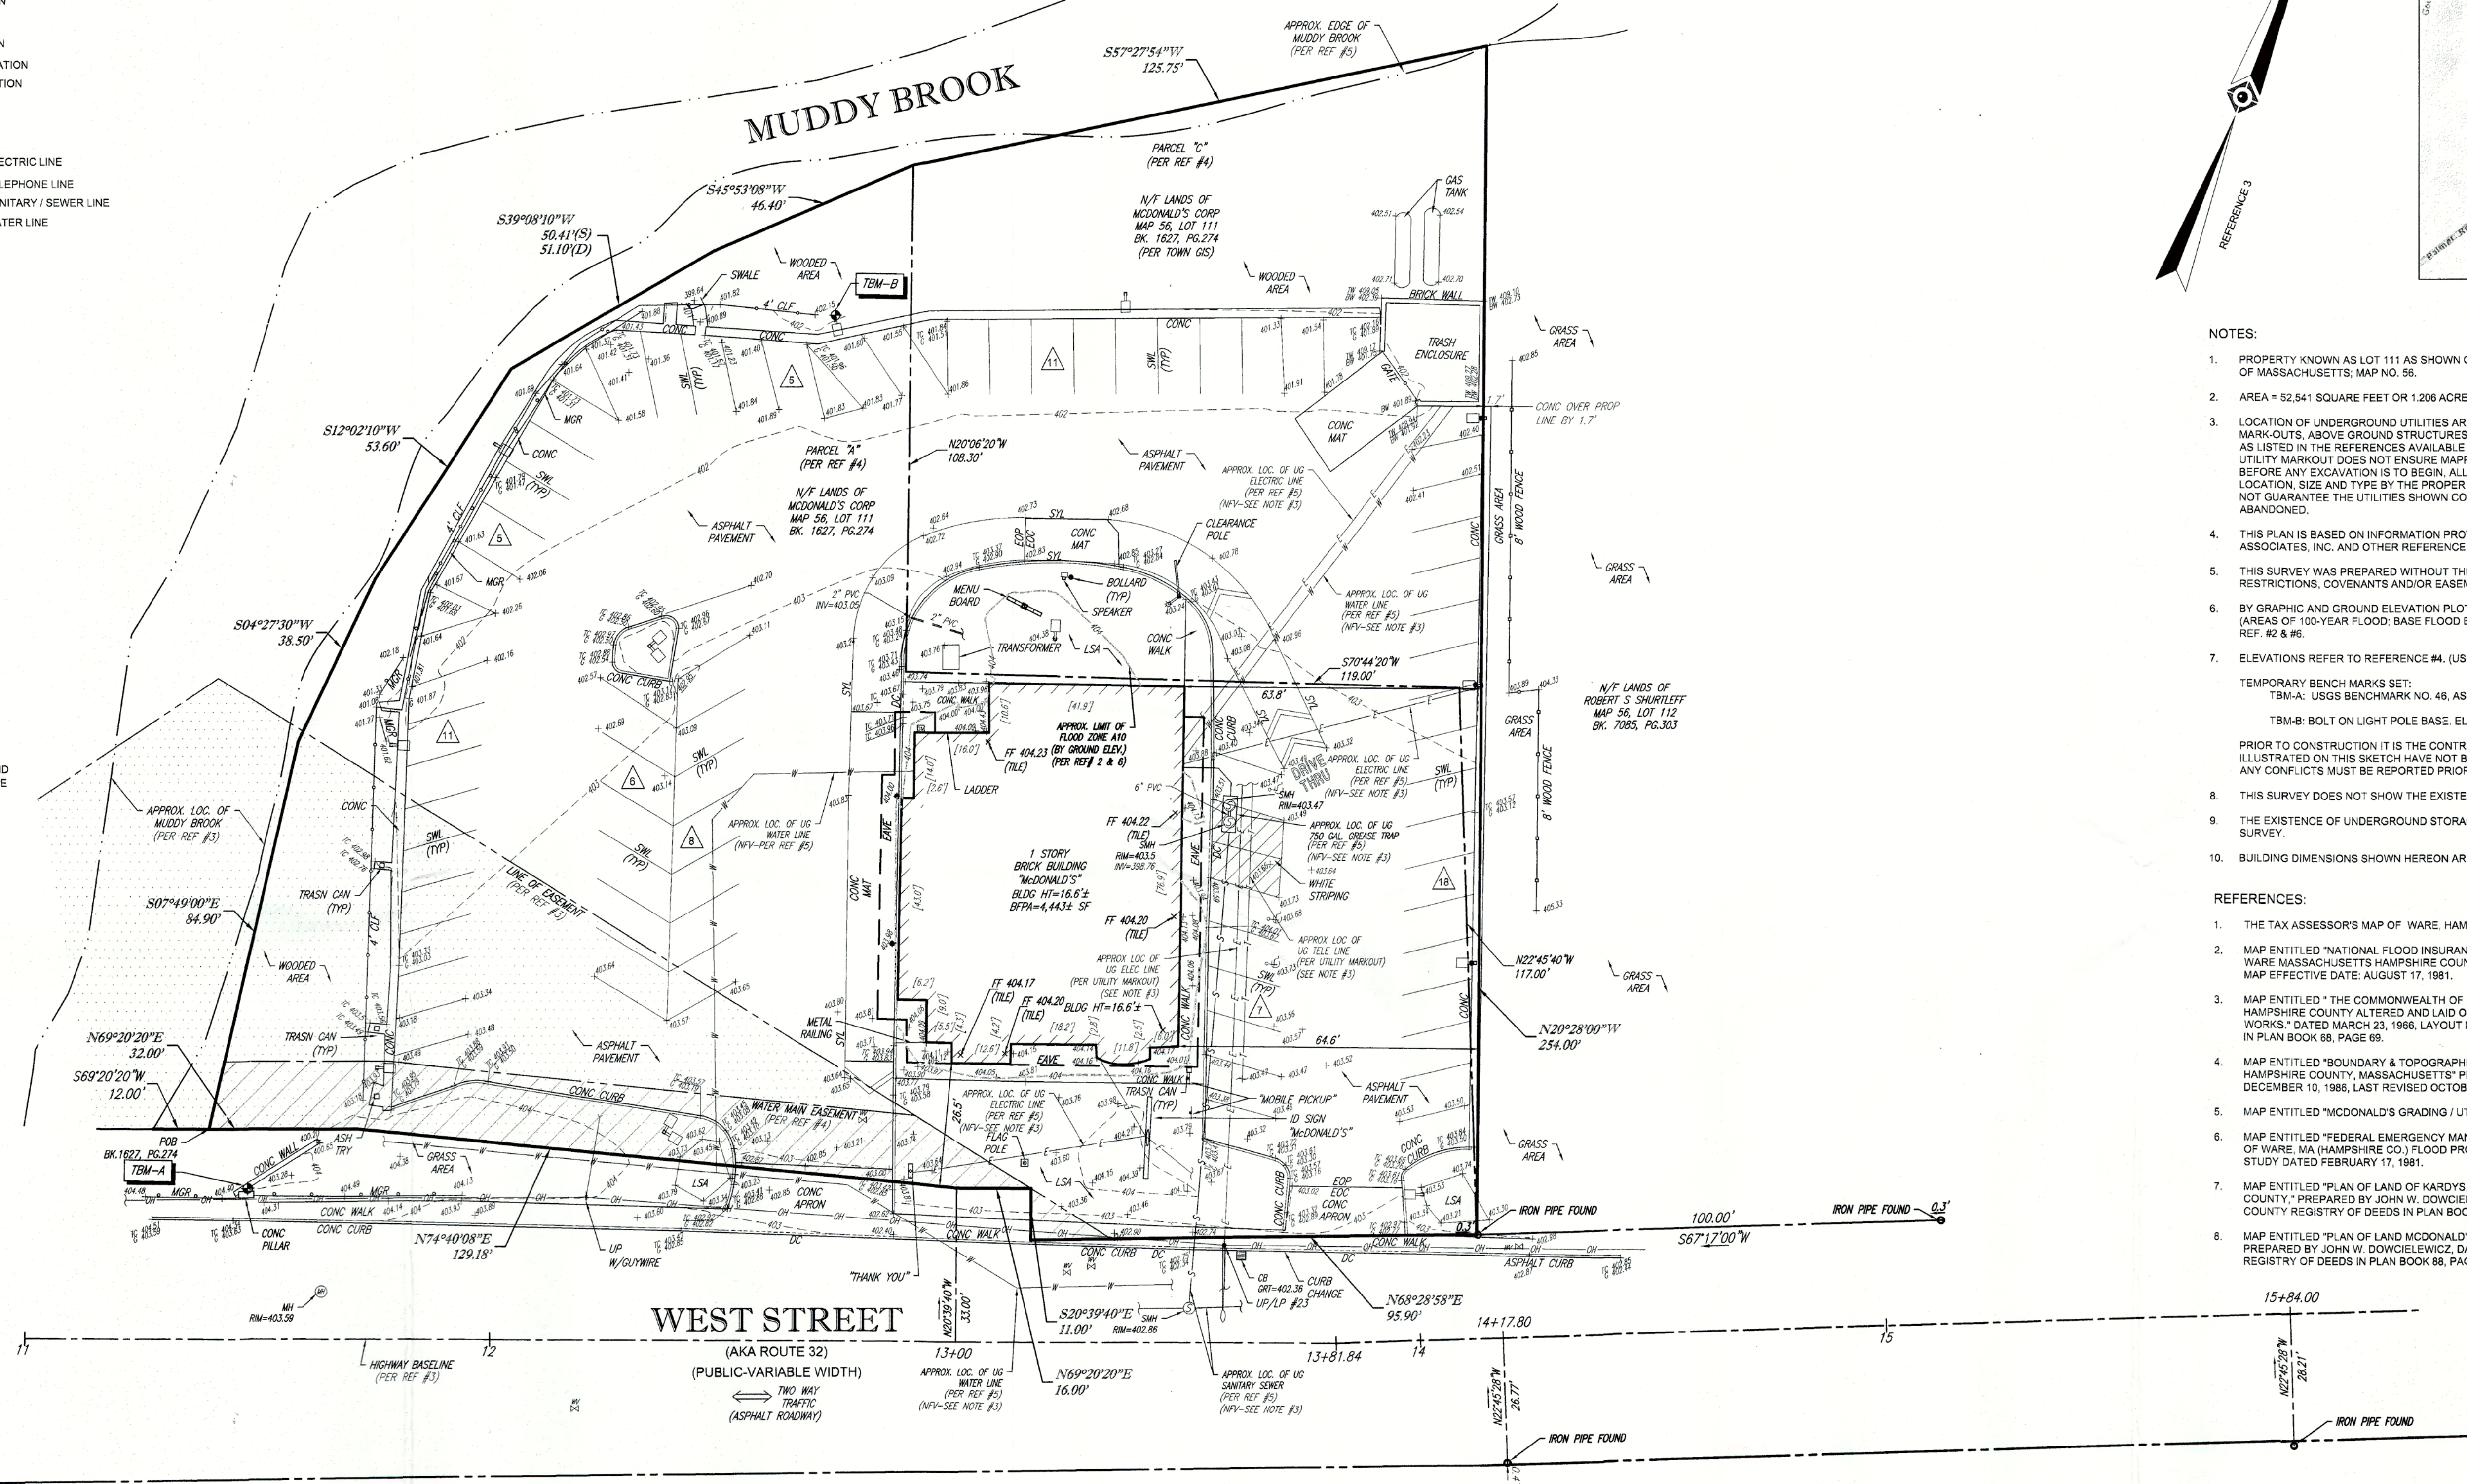
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PLAN APPROVALS
SIGNATURE
DATE

REV	DATE	DESCRIPTION
1	05/10/2022	REVISED PER CONSERVATION COMMISSION COMMENTS
2	06/09/2022	REVISED PER CONSERVATION COMMISSION COMMENTS

- LEGEND
- 124 EXISTING CONTOUR
 - 125 EXISTING SPOT ELEVATION
 - 123.45 EXISTING TOP OF CURB ELEVATION
 - 122.95 EXISTING GUTTER ELEVATION
 - 123.45 EXISTING TOP OF WALL ELEVATION
 - 122.95 EXISTING BOTTOM OF WALL ELEVATION
 - 123.45 EXISTING FINISHED FLOOR ELEVATION
 - 122.95 EXISTING WATER VALVE
 - 123.45 GAS METER
 - OH OVERHEAD WIRES
 - E APPROX. LOC. UNDERGROUND ELECTRIC LINE
 - T APPROX. LOC. UNDERGROUND TELEPHONE LINE
 - S APPROX. LOC. UNDERGROUND SANITARY / SEWER LINE
 - W APPROX. LOC. UNDERGROUND WATER LINE
 - UP UTILITY POLE
 - GW GUY WIRE
 - AREA LIGHT
 - SIGN
 - BOLLARD
 - METAL GUIDE RAIL
 - PAINTED ARROWS
 - CLF CHAIN LINK FENCE
 - LSA LANDSCAPED AREA
 - TYPICAL
 - SMW SANITARY/SEWER MANHOLE
 - CB CATCH BASIN OR INLET
 - PARKING SPACE COUNT
 - DEPRESSED CURB
 - SML SOLID WHITE LINE
 - STL SOLID YELLOW LINE
 - HT HEIGHT
 - BLDG BUILDING
 - BFTA BUILDING FOOTPRINT AREA
 - PVC POLYVINYL CHLORIDE PIPE
 - INV INVERT ELEVATION
 - GRT GRATE ELEVATION
 - [41.9] BUILDING DIMENSION
 - MGR METAL GUIDE RAIL
 - 1.0' OFFSET OF STRUCTURE AT GROUND LEVEL RELATIVE TO PROPERTY LINE



- NOTES:
- PROPERTY KNOWN AS LOT 111 AS SHOWN ON THE TOWN OF WARE, HAMPSHIRE COUNTY, COMMONWEALTH OF MASSACHUSETTS; MAP NO. 56.
 - AREA = 52,541 SQUARE FEET OR 1.206 ACRES
 - LOCATION OF UNDERGROUND UTILITIES ARE APPROXIMATE. LOCATIONS AND SIZES ARE BASED ON UTILITY MARK-OUTS, ABOVE GROUND STRUCTURES THAT WERE VISIBLE & ACCESSIBLE IN THE FIELD, AND THE MAPS AS LISTED IN THE REFERENCES AVAILABLE AT THE TIME OF THE SURVEY. AVAILABLE AS-BUILT PLANS AND UTILITY MARK-OUT DOES NOT ENSURE MAPPING OF ALL UNDERGROUND UTILITIES AND STRUCTURES. BEFORE ANY EXCAVATION IS TO BEGIN, ALL UNDERGROUND UTILITIES SHOULD BE VERIFIED AS TO THEIR LOCATION, SIZE AND TYPE BY THE PROPER UTILITY COMPANIES. CONTROL POINT ASSOCIATES, INC. DOES NOT GUARANTEE THE UTILITIES SHOWN COMPRISE ALL. SUCH UTILITIES IN THE AREA EITHER IN SERVICE OR ABANDONED.
 - THIS PLAN IS BASED ON INFORMATION PROVIDED BY A SURVEY PREPARED IN THE FIELD BY CONTROL POINT ASSOCIATES, INC. AND OTHER REFERENCE MATERIAL AS LISTED HEREON.
 - THIS SURVEY WAS PREPARED WITHOUT THE BENEFIT OF A TITLE REPORT AND IS SUBJECT TO THE RESTRICTIONS, COVENANTS AND/OR EASEMENTS THAT MAY BE CONTAINED THEREIN.
 - BY GRAPHIC AND GROUND ELEVATION PLOTTING PROPERTY IS LOCATED IN FLOOD HAZARD ZONE A10 (AREAS OF 100-YEAR FLOOD; BASE FLOOD ELEVATIONS AND FLOOD HAZARD FACTORS DETERMINED) PER REF. #2 & #6.
 - ELEVATIONS REFER TO REFERENCE #4. (USGS NGVD29).
- TEMPORARY BENCH MARKS SET:
- TBM-A: USGS BENCHMARK NO. 46, ASSUMED ELEVATION OF 402.39.
 - TBM-B: BOLT ON LIGHT POLE BASE. ELEVATION = 403.77.
- PRIOR TO CONSTRUCTION IT IS THE CONTRACTOR'S RESPONSIBILITY TO VERIFY THAT THE BENCHMARKS ILLUSTRATED ON THIS SKETCH HAVE NOT BEEN DISTURBED AND THEIR ELEVATIONS HAVE BEEN CONFIRMED. ANY CONFLICTS MUST BE REPORTED PRIOR TO CONSTRUCTION.
- THIS SURVEY DOES NOT SHOW THE EXISTENCE OF WETLANDS, IF ANY.
 - THE EXISTENCE OF UNDERGROUND STORAGE TANKS, IF ANY, WAS NOT KNOWN AT THE TIME OF THE FIELD SURVEY.
 - BUILDING DIMENSIONS SHOWN HEREON ARE MEASURED AT GROUND LEVEL OF BUILDING EXTERIOR.

- REFERENCES:
- THE TAX ASSESSOR'S MAP OF WARE, HAMPSHIRE COUNTY, MAP #56.
 - MAP ENTITLED "NATIONAL FLOOD INSURANCE PROGRAM, FIRM, FLOOD INSURANCE RATE MAP, TOWN OF WARE MASSACHUSETTS HAMPSHIRE COUNTY, PANEL 22 OF 30, COMMUNITY-PANEL NUMBER 250172 0022 B, MAP EFFECTIVE DATE: AUGUST 17, 1981.
 - MAP ENTITLED "THE COMMONWEALTH OF MASSACHUSETTS PLAN OF ROAD IN THE TOWN OF WARE HAMPSHIRE COUNTY ALTERED AND LAID OUT AS A STATE HIGHWAY, BY THE DEPARTMENT OF PUBLIC WORKS, DATED MARCH 23, 1986, LAYOUT NO. 5566, RECORDED WITH THE HAMPSHIRE REGISTRY OF DEEDS IN PLAN BOOK 68, PAGE 69.
 - MAP ENTITLED "BOUNDARY & TOPOGRAPHIC SURVEY FOR MCDONALD'S, WEST STREET, TOWN OF WARE, HAMPSHIRE COUNTY, MASSACHUSETTS" PREPARED BY HOFFMAN ENGINEERS & SURVEYORS DATED DECEMBER 10, 1988, LAST REVISED OCTOBER 5, 1987.
 - MAP ENTITLED "MCDONALD'S GRADING / UTILITY PLAN SP-2" DATED JULY 23, 1987 DRAWN BY ADAM MAKAS.
 - MAP ENTITLED "FEDERAL EMERGENCY MANAGEMENT AGENCY FEDERAL INSURANCE ADMINISTRATION TOWN OF WARE, MA (HAMPSHIRE CO.) FLOOD PROFILES MUDDY BROOK" SHEET CAP OF THE FLOOD INSURANCE STUDY DATED FEBRUARY 17, 1981.
 - MAP ENTITLED "PLAN OF LAND OF KARDY'S, 117 & 119 WEST STREET, WARE MASSACHUSETTS, HAMPSHIRE COUNTY," PREPARED BY JOHN W. DOWCIELEWICZ, DATED MARCH 4, 1972, RECORDED WITH THE HAMPSHIRE COUNTY REGISTRY OF DEEDS IN PLAN BOOK 81, PAGE 58.
 - MAP ENTITLED "PLAN OF LAND MCDONALD'S CORPORATION, WARE MASSACHUSETTS, HAMPSHIRE COUNTY," PREPARED BY JOHN W. DOWCIELEWICZ, DATED AUGUST 13, 1973, RECORDED WITH THE HAMPSHIRE COUNTY REGISTRY OF DEEDS IN PLAN BOOK 88, PAGE 75.

UTILITIES:


THE FOLLOWING COMPANIES WERE NOTIFIED BY MASSACHUSETTS ONE-CALL SYSTEM (1-888-344-7233) AND REQUESTED TO MARK OUT UNDERGROUND FACILITIES AFFECTING AND SERVICING THIS SITE. THE UNDERGROUND UTILITY INFORMATION SHOWN HEREON IS BASED UPON THE UTILITY COMPANIES RESPONSE TO THIS REQUEST. REQUEST NUMBER(S): 20180201683

UTILITY COMPANY
AMERIGAS - PALMER
COMCAST - SOUTH BURLINGTON
NATIONAL GRID ELECTRIC-MASS ELEC
OSTERMAN PROPANE
VERIZON
ON TARGET LOCATING

PHONE NUMBER
800-263-7442
800-934-6489
800-322-3223
800-332-3353
800-922-0204
508-428-1022




THE COMMONWEALTH OF MASSACHUSETTS REQUIRES NOTIFICATION BY EXCAVATORS, DESIGNERS OR ANY PERSON PREPARING TO DISTURB THE EARTH'S SURFACE ANYWHERE IN THE COMMONWEALTH.

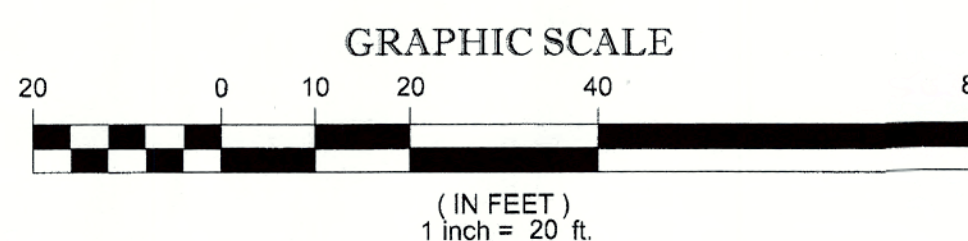

THIS SURVEY HAS BEEN PERFORMED IN THE FIELD UNDER MY SUPERVISION, AND TO THE BEST OF MY KNOWLEDGE, BELIEF, AND INFORMATION, THIS SURVEY HAS BEEN PERFORMED IN ACCORDANCE WITH CURRENTLY ACCEPTED ACCURACY STANDARDS.

NOT A VALID ORIGINAL DOCUMENT UNLESS EMBOSSED WITH RAISED IMPRESSION OR STAMPED WITH A BLUE INK SEAL.

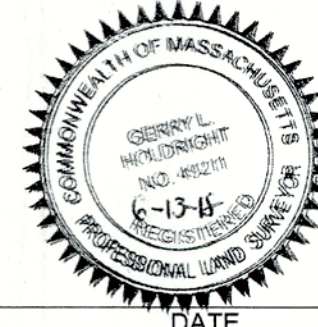

GERRY L. HOLDRIGHT, PLS
MASSACHUSETTS PROFESSIONAL LAND SURVEYOR #49211

REVISED PER ENGINEERS COMMENTS		E.L.C.		G.L.H.		6-13-18	
No.	DESCRIPTION OF REVISION	FIELD CREW	DRAWN	APPROVED	DATE		
1	FIELD DATE 1/31/18						
2	FIELD BOOK NO. 1-MA						
3	FIELD BOOK PG. 52						
4	FIELD CREW A.S.P.						
5	DRAWN PRIMA						
6	REVIEWED R.D.N.						
7	APPROVED G.L.H.						
8	DATE 2-12-18						
9	SCALE 1"=20'						
10	FILE NO. 03-170294-00						
11	DWG. NO. 1 OF 1						

BOUNDARY & TOPOGRAPHIC SURVEY
MCDONALD'S USA, LLC
117-119 WEST STREET
MAP 56, LOT 111
TOWN OF WARE
HAMPSHIRE COUNTY
COMMONWEALTH OF MASSACHUSETTS

CONTROL POINT ASSOCIATES, INC.
ALBANY, NY 5182175010
CHALFONTE, PA 2157128600
MANHATTAN, NY 6087800411
MT LAUREL, NJ 6088572099
WARREN, NJ 9086809099